

Vicinity Map (No Scale)

TRACT AREA--14.78 AC --643.816.80 SF ZONING--MF-M PROPOSED UNITS--200 UNITS PER ACRE--13.53 TAX PIN--R04812-001-004-000 DEED BOOK/PAGE--6018/1545 CAMA LUC--URBAN EXISTING BUA--0 SF PROPOSED BUA--288.409.77 SF --6.62 AC % BUA--44.80% RECIEVING STREAM--SMITH CREEK CLASSIFICATION--C;SW SETBACKS-FRONT--35' REQ'D 35' PROP. REAR--25' REQ'D 25' PROP. SIDE--20' REQ'D 20' PROP. CORNER-N/A MAX HEIGHT--35 TRACT AREA--14.78 AC MAX HEIGHT--35

SITE DATA

- THIS SITE IS NOT RECOGNIZED AS A LOCAL, STATE
 OR FEDERALLY HISTORIC OR ARCHAEOLOGICAL SITE.
 THERE ARE NO KNOWN CEMETERIES. BURIAL SITES.
 OR BURIAL GROUNDS ON THIS SITE.
 THERE ARE NO KNOWN PROTECTED SPECIES OR
 HABITATS ON THIS SITE.
 THERE ARE NO EXISTING OR PROPOSED THOROUGHFARES.
 BIKE ROUTES, PEDESTRIAN SIDEWALKS OR TRAILS AND
 TRANSIT FACILITIES ON THIS SITE, EXCEPT THOSE
 DEPICTED ON THIS PLAN.
 IMPROVEMENTS DO NOT ENCROACH INTO THE CONSERVATION
 RESOURCE SETBACK.
 PRIOR TO ANY CLEARING, GRADING OR CONSTRUCTION ACTIVITY.
 TREE PROTECTION FENCING SHALL BE INSTALLED AROUND
 PROTECTED TREES OR GROVES OF TREES. NO CONSTRUCTION
 WORKERS, TOOLS, MATERIALS, OR VEHICLES ARE PERMITTED
 WITHIN THE TREE PROTECTION FENCING.
 ANY TREES AND/OR AREAS DESIGNATED TO BE PROTECTED MUST
 BE PROPERLY BARRICADED WITH FENCING AND PROTECTED
 THROUGHOUT CONSTRUCTIO TO INSURE THAT NO CLEARING,
 GRADING OR STAGING OF MATERIALS WILL OCCUR IN THOSE
 AREAS.
- ARLAS.
 NO EQUIPMENT IS ALLOWED ON SITE UNTIL ALL TREE
 PROTECTION FENCING AND SILT FENCING IS INSTALLED AND
 APPROVED. PROTECTIVE FENCING IS TO BE MAINTAINED
 THROUGHOUT THE DURATION OF THE PROJECT. AND CONTRACTORS
 SHALL RECEIVE ADEQUATE INSTRUCTION ON TREE PROTECTION

- APPROVED. "PROTECTIVE FENCING IS TO BE MAINTAINED THROUGHOUT THE DURATION OF THE PROJECT, AND CONTRACTORS SHALL RECEIVE ADEQUATE INSTRUCTION ON TREE PROTECTION

 9. ALTHOUMENT MARKINGS IN PUBLIC RIGHTS—OF—WAY AND CONTRACTORS SHALL RECEIVE ADEQUATE INSTRUCTION ON TREE PROTECTION

 9. ALTHOUMENT MARKINGS IN PUBLIC RIGHTS—OF—WAY AND CONTRACT TRAFFIC CONTRACT TRAFFIC CITY AND/OR ROOTOR STANDARDS.

 10. FOR STREETS ARE OPEN TO TRAFFIC, CONTACT TRAFFIC ENGINEERING REGARDING THE INSTALLATION OF TRAFFIC AND STREET NAME SIONS. PROPOSED STREET NAMES MUST BE ONS.

 11. TRAFFIC CONTROL DEVICELL INCLIDING SIGNS AND PAVEMENT MAINTAINED TO PUBLIC TRAFFIC CONTROL DEVICES STANDARDS. IDETAIL SO THE TOTAL TRAFFIC CONTROL DEVICES STANDARDS. IDETAIL SO THE TOTAL STANDARDS. IDETAIL SO THE TOTAL SO TH


- SHEET #CO1 OF 10

DESIGN FILE #: Construction Drawings.dgn

PROJECT #:PM858-36'-001


CYPRESS COVE APARTMENTS

WILMINGTON, NC APRIL 14th, 2017 REVISED: JUNE 6th, 2017

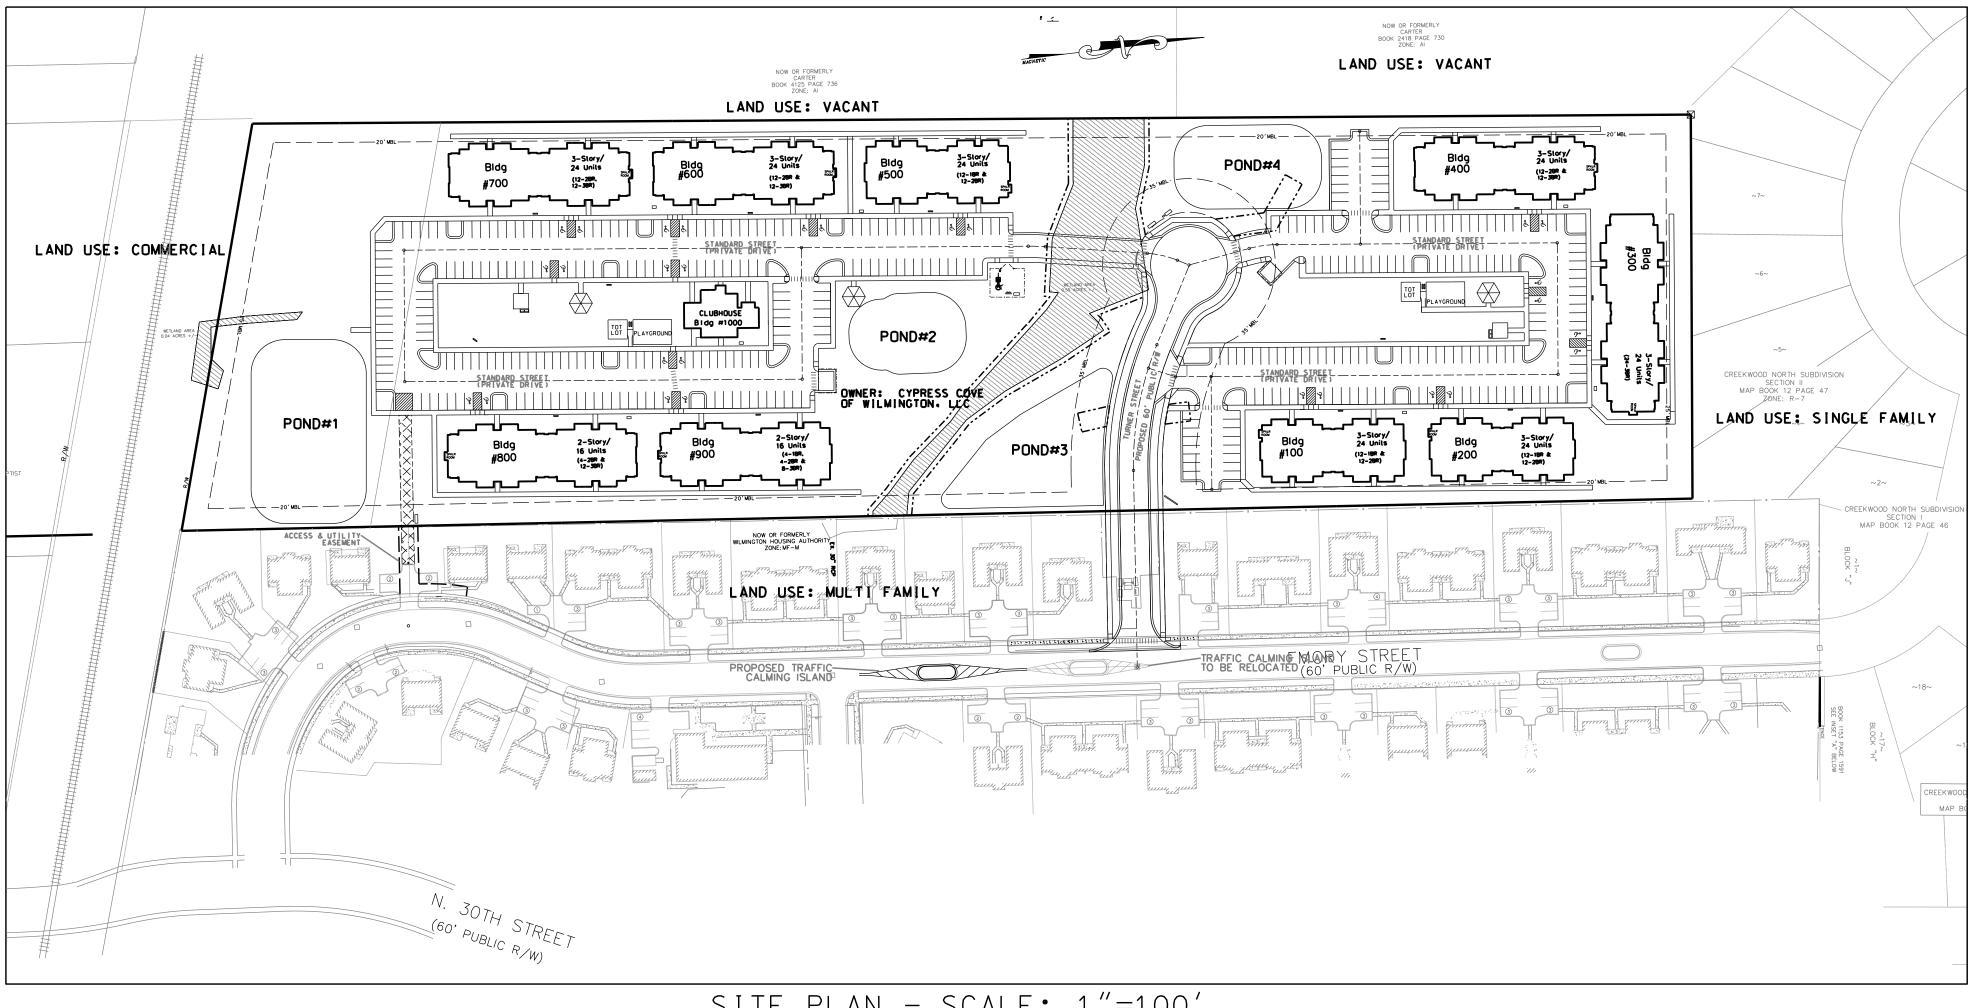

SITE PLAN - SCALE: 1"=100

CAPE FEAR PUBLIC UTILITY AUTHORITY STANDARD SEWER AND WATER NOTES:	BUILDING DATA	OPEN SPACE CALCULATIONS
 WATER AND SEWER SERVICES SHALL MEET CAPE FEAR PUBLIC UTILITY AUTHORITY (CFPUA) DETAILS AND SPRCIFICATIONS. SEWER GUARDS REQUIRED AT ALL MANHOLES. STAINLESS STEEL SEWER GUARDS REQUIRED AT MANHOLES LOCATED IN TRAFFIC AREAS. SERVICES SHALL BE PERPENDICULAR TO MAIN AND TERMINATE AT RIGHT-OF-WAY LINE. SERVICES IN CUL-DE-SACS ARE REQUIRED TO BE PERPENDICULAR, OR MUST ORIGINATE IN MANHOLE AND TERMINATE AT RIGHT-OF-WAY LINE. ALL SERVICES TYING INTO DUCTILE IRON MAINS SHALL BE CONSTRUCTED OF CLASS 50 DIP WITH PROTECTO 401 CERAMIC EPOXY LINING. MINIMUM 10' UTILITIES EASEMENT PROVIDED ALONG THE FRONTAGE OF ALL LOTS AND AS SHOWN FOR NEW DEVELOPMENTS. ON 6. NO FLEXIBLE COUPLINGS SHALL BE USED. ALL STAINLESS STEEL FASTENERS SHALL BE 316. PROJECT SHALL COMPLY WITH CFPUA CROSS CONNECTION CONTROL REQUIREMENTS. WATER METER(S) CANNOT BE RELEASED UNTIL ALL 	BUILDING # NUMBER OF UNITS	TRACT AREA = 14.78 AC POND #1 = 0.46 AC POND #2 = 0.26 AC POND #3 = 0.27 AC POND #4 = 0.40 AC REMAINING AREA = 13.39 AC OPEN AREA REQUIRED = 35% OF 13.39 AC OPEN AREA REQUIRED = 4.69 AC PASSIVE AREAS PROVIDED = 2.36 AC ACTIVE AREAS PROVIDED = 2.85 AC TOTAL OPEN SPACE PROVIDED = 5.21 AC
REQUIREMENTS ARE MET AND THE STATE HAS GIVEN THEIR FINAL APPROVAL. CALL 910-343-3910 FOR INFORMATION. 9. IF THE CONTRACTOR DESIRES CFPUA WATER FOR CONSTRUCTION, HE	PARKING DATA	FLOOD DATA
SHALL APPLY IN ADVANCE FOR THIS SERVICE AND MUST PROVIDE A REDUCED PRESSURE ZONE (RPZ) BACKFLOW PREVENTION DEVICE ON THE DEVELOPER'S SIDE OF THE WATER METER BOX.	PARKING REO'D = 400 (NCHFA 2016 QAP) PARKING SPACES = 400 TOTAL	MAP NUMBER: 3720313800J PANEL: 3138 ZONE:X
10. ANY IRRIGATION SYSTEM SUPPLIED BY CFPUA WATER SHALL COMPLY WITH THE CFPUA CROSS CONNECTION CONTROL REGULATIONS. CALL 910-343-3910 FOR INFORMATION. 11. ANY IRRIGATION SYSTEM SHALL BE EQUIPPED WITH RAIN AND FREEZER SENSOR (SHALL UTILIZE MOISTURE SENSORS). 12. ANY BACKFLOW PREVENTION DEVICES REQUIRED BY THE CFPUA WILL NEED TO BE ON THE LIST OF APPROVED DEVICES BY USCFCCCHR OR ASSE. 13. CONTRACTOR TO FIELD VERIFY EXISTING WATER AND SEWER SERVICE LOCATIONS. SIZES AND MATERIALS PRIOR TO CONSTRUCTION. ENGINEER TO BE NOTIFIED OF ANY CONFLICTS.	PARKING REQ'D (WILMINGTON) = 1.5 SPACE PER 1 BEDROOM UNITS, 2 SPACES PER 2 BEDROOM UNIT & 2.25 SPACES PER 3 BEDROOMS AND GREATER UNITS PARKING REQ'D (WILMINGTON) = (40×1.5)+(80×2)+(80×2.25)=400 SPACES REQ'D PARKING PROVIDED = 400 SPACES HANDICAP(H/C) PARKING REQ'D (WILMINGTON) = 2% OF 400 = 8 SPACES REQ'D HANDICAP(H/C) PARKING PROVIDED = 28 SPACES	
STREET	BICYCLE PARKING REQUIRED = 25 SPACES BICYCLE PARKING PROVIDED = 35 SPACES	

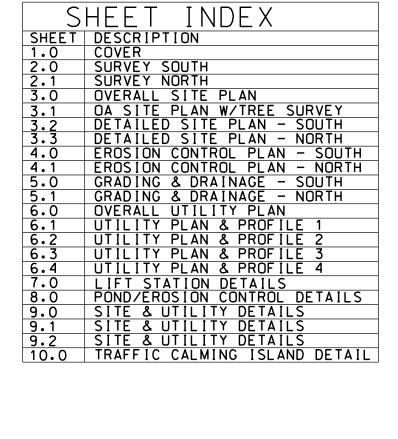

For each open utility cut of City streets, a \$325 permit shall be required from the City prior to occupancy and/or project acceptance



REVISIONS: No. BY DATE DESCRIPTION CMC 3/20/17 PER WLM H.A.& ACOE CMC 4/6/17 PER WLM S.R.B. CMC 4/10/17 PER WLM T.R.C. 4 CMC 6/6/17 PER WLM COMMENTS

DESIGNED:

DRAWN:

CMC

CMC CHECKED:

CMC APPROVED:

CMC

1 "=100'

PIN:R04812-001-004-000 COVER SHEET

SEAL

037378

PO NGINEER


CYPRESS COVE APARTMENTS 821 EMORY STREET


WILMINGTON TWSP., NEW HANOVER COUNTY, NORTH CAROLINA CYPRESS COVE OF WILMINGTON, LLC PO BOX 2400 BEAUFORT, NC 28516


PHONE: 252-504-3996


STROUD ENGINEERING, P.A. / 151A HIGHWAY 24 MOREHEAD CITY, N.C. 28557 (252) 247-7479


LICENSE NO. C-0647 4/10/17 SCALE: CHARLES M. CULLIPHER P.E.

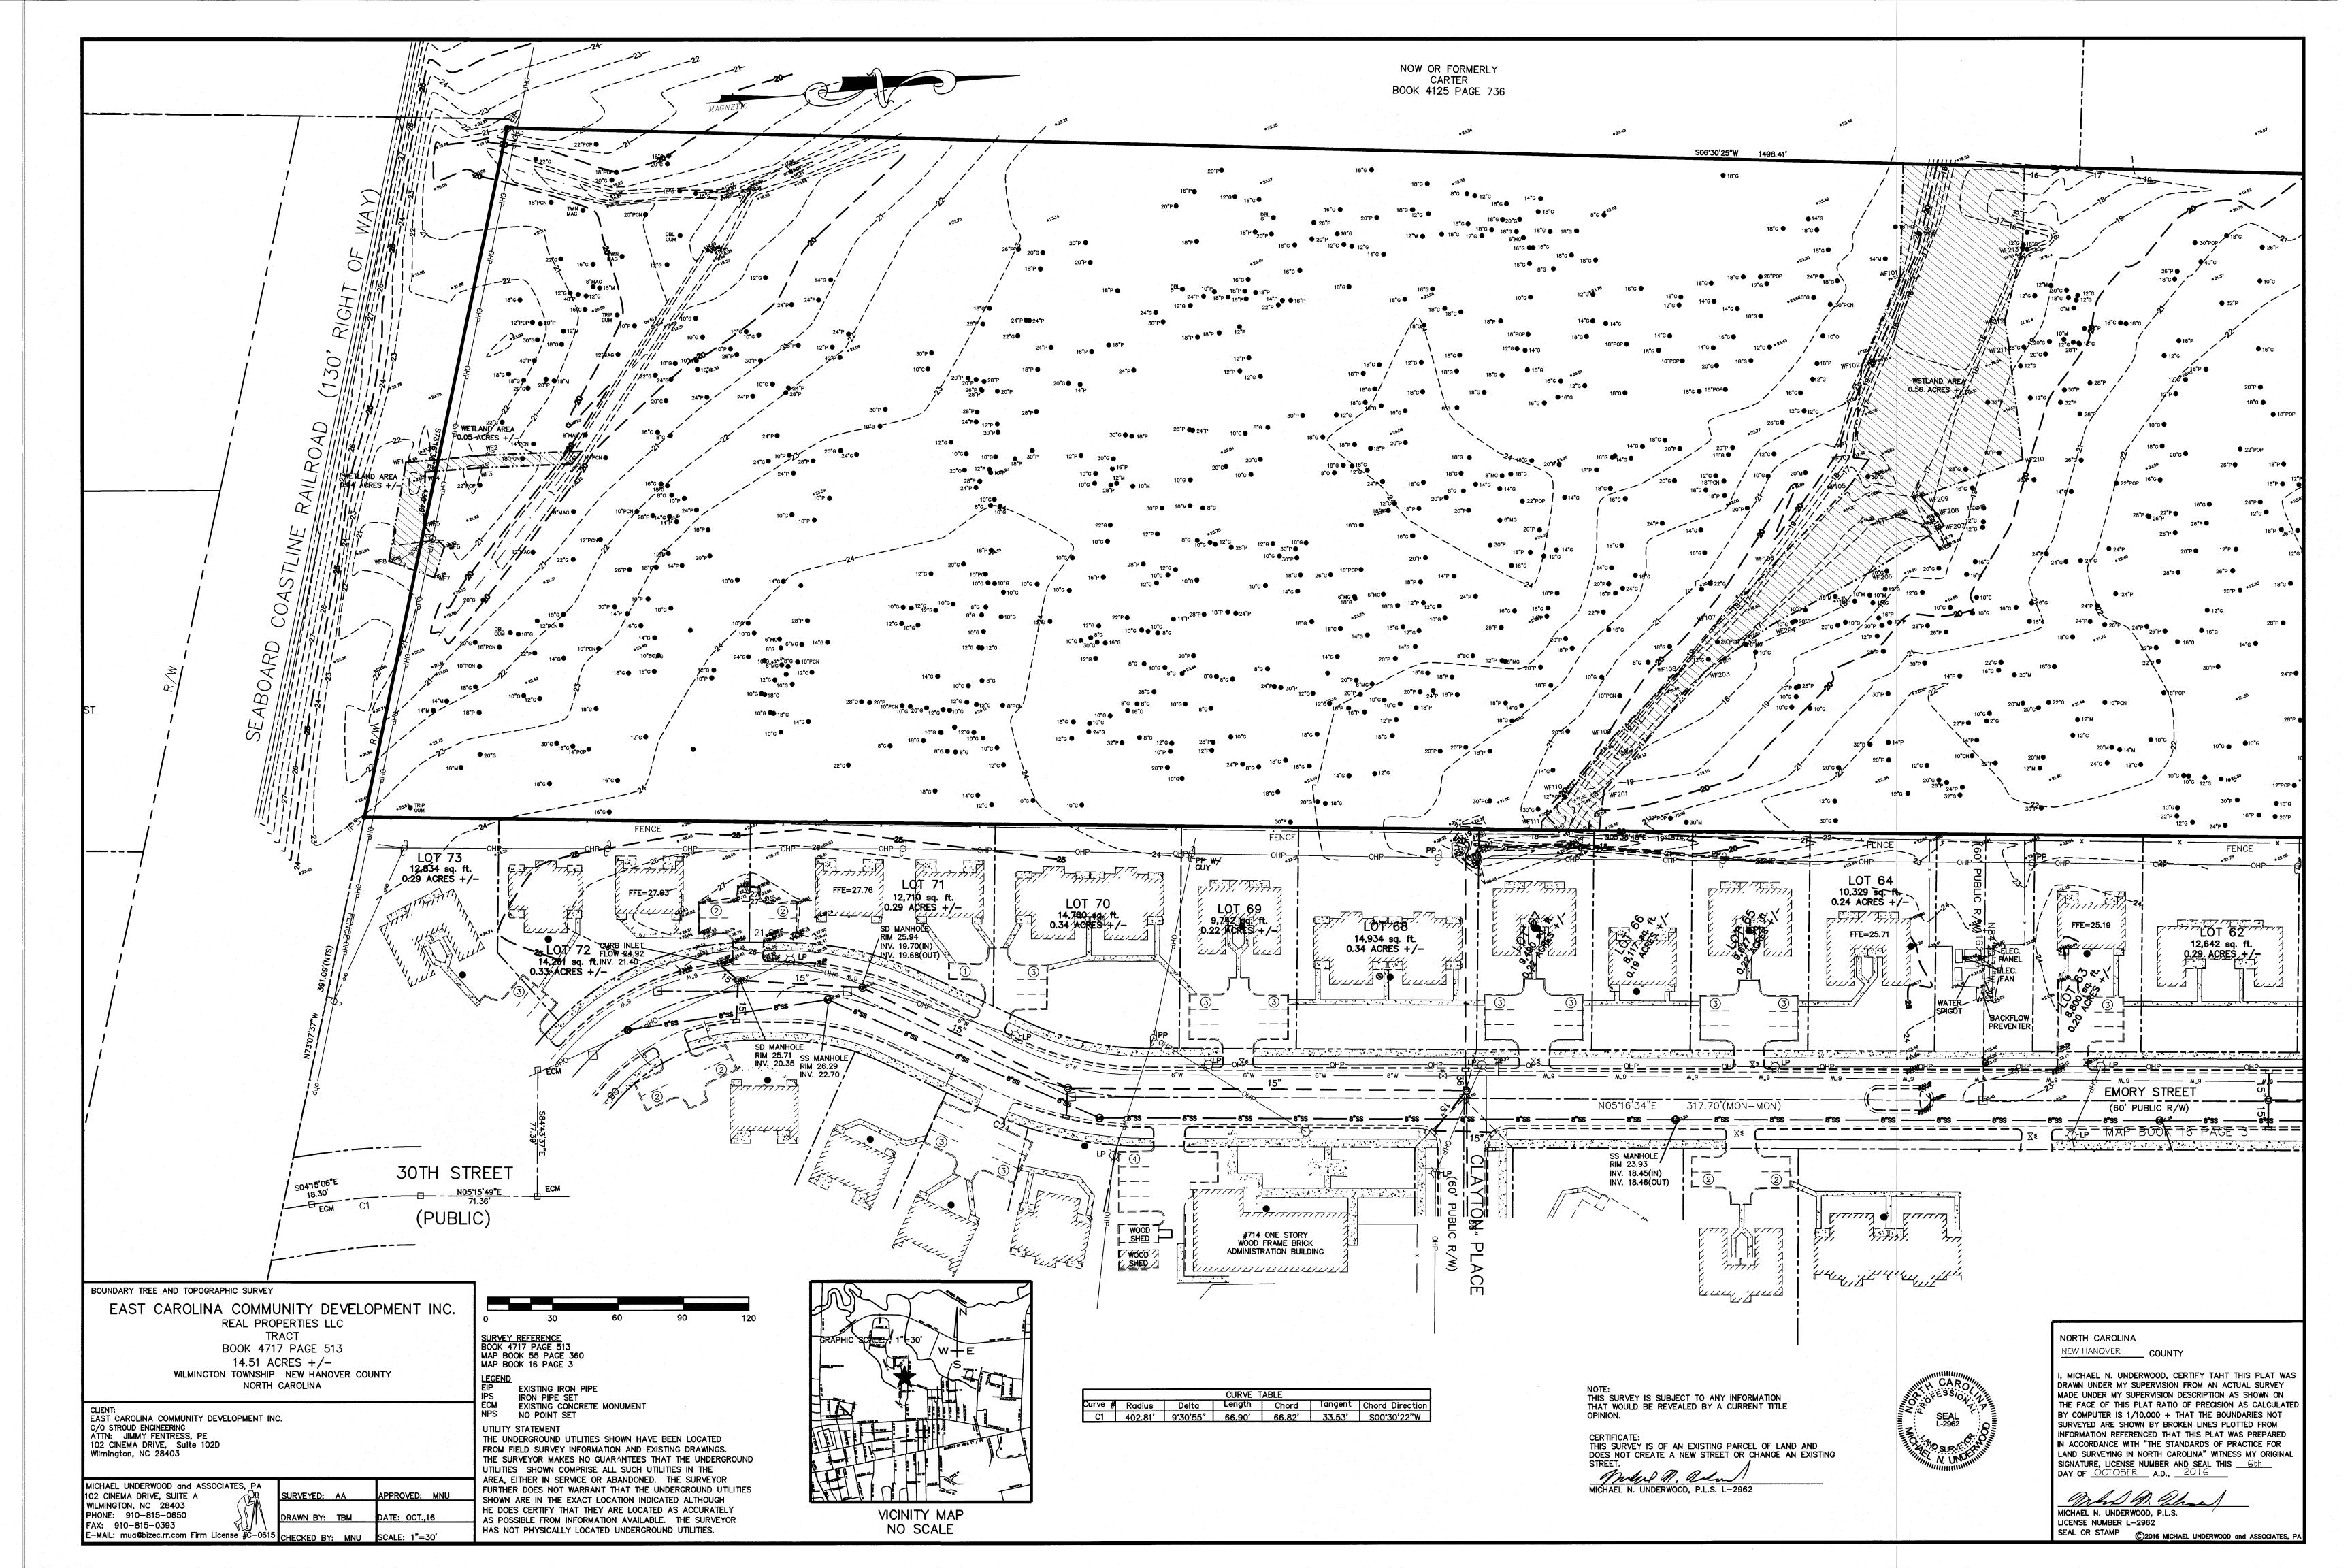


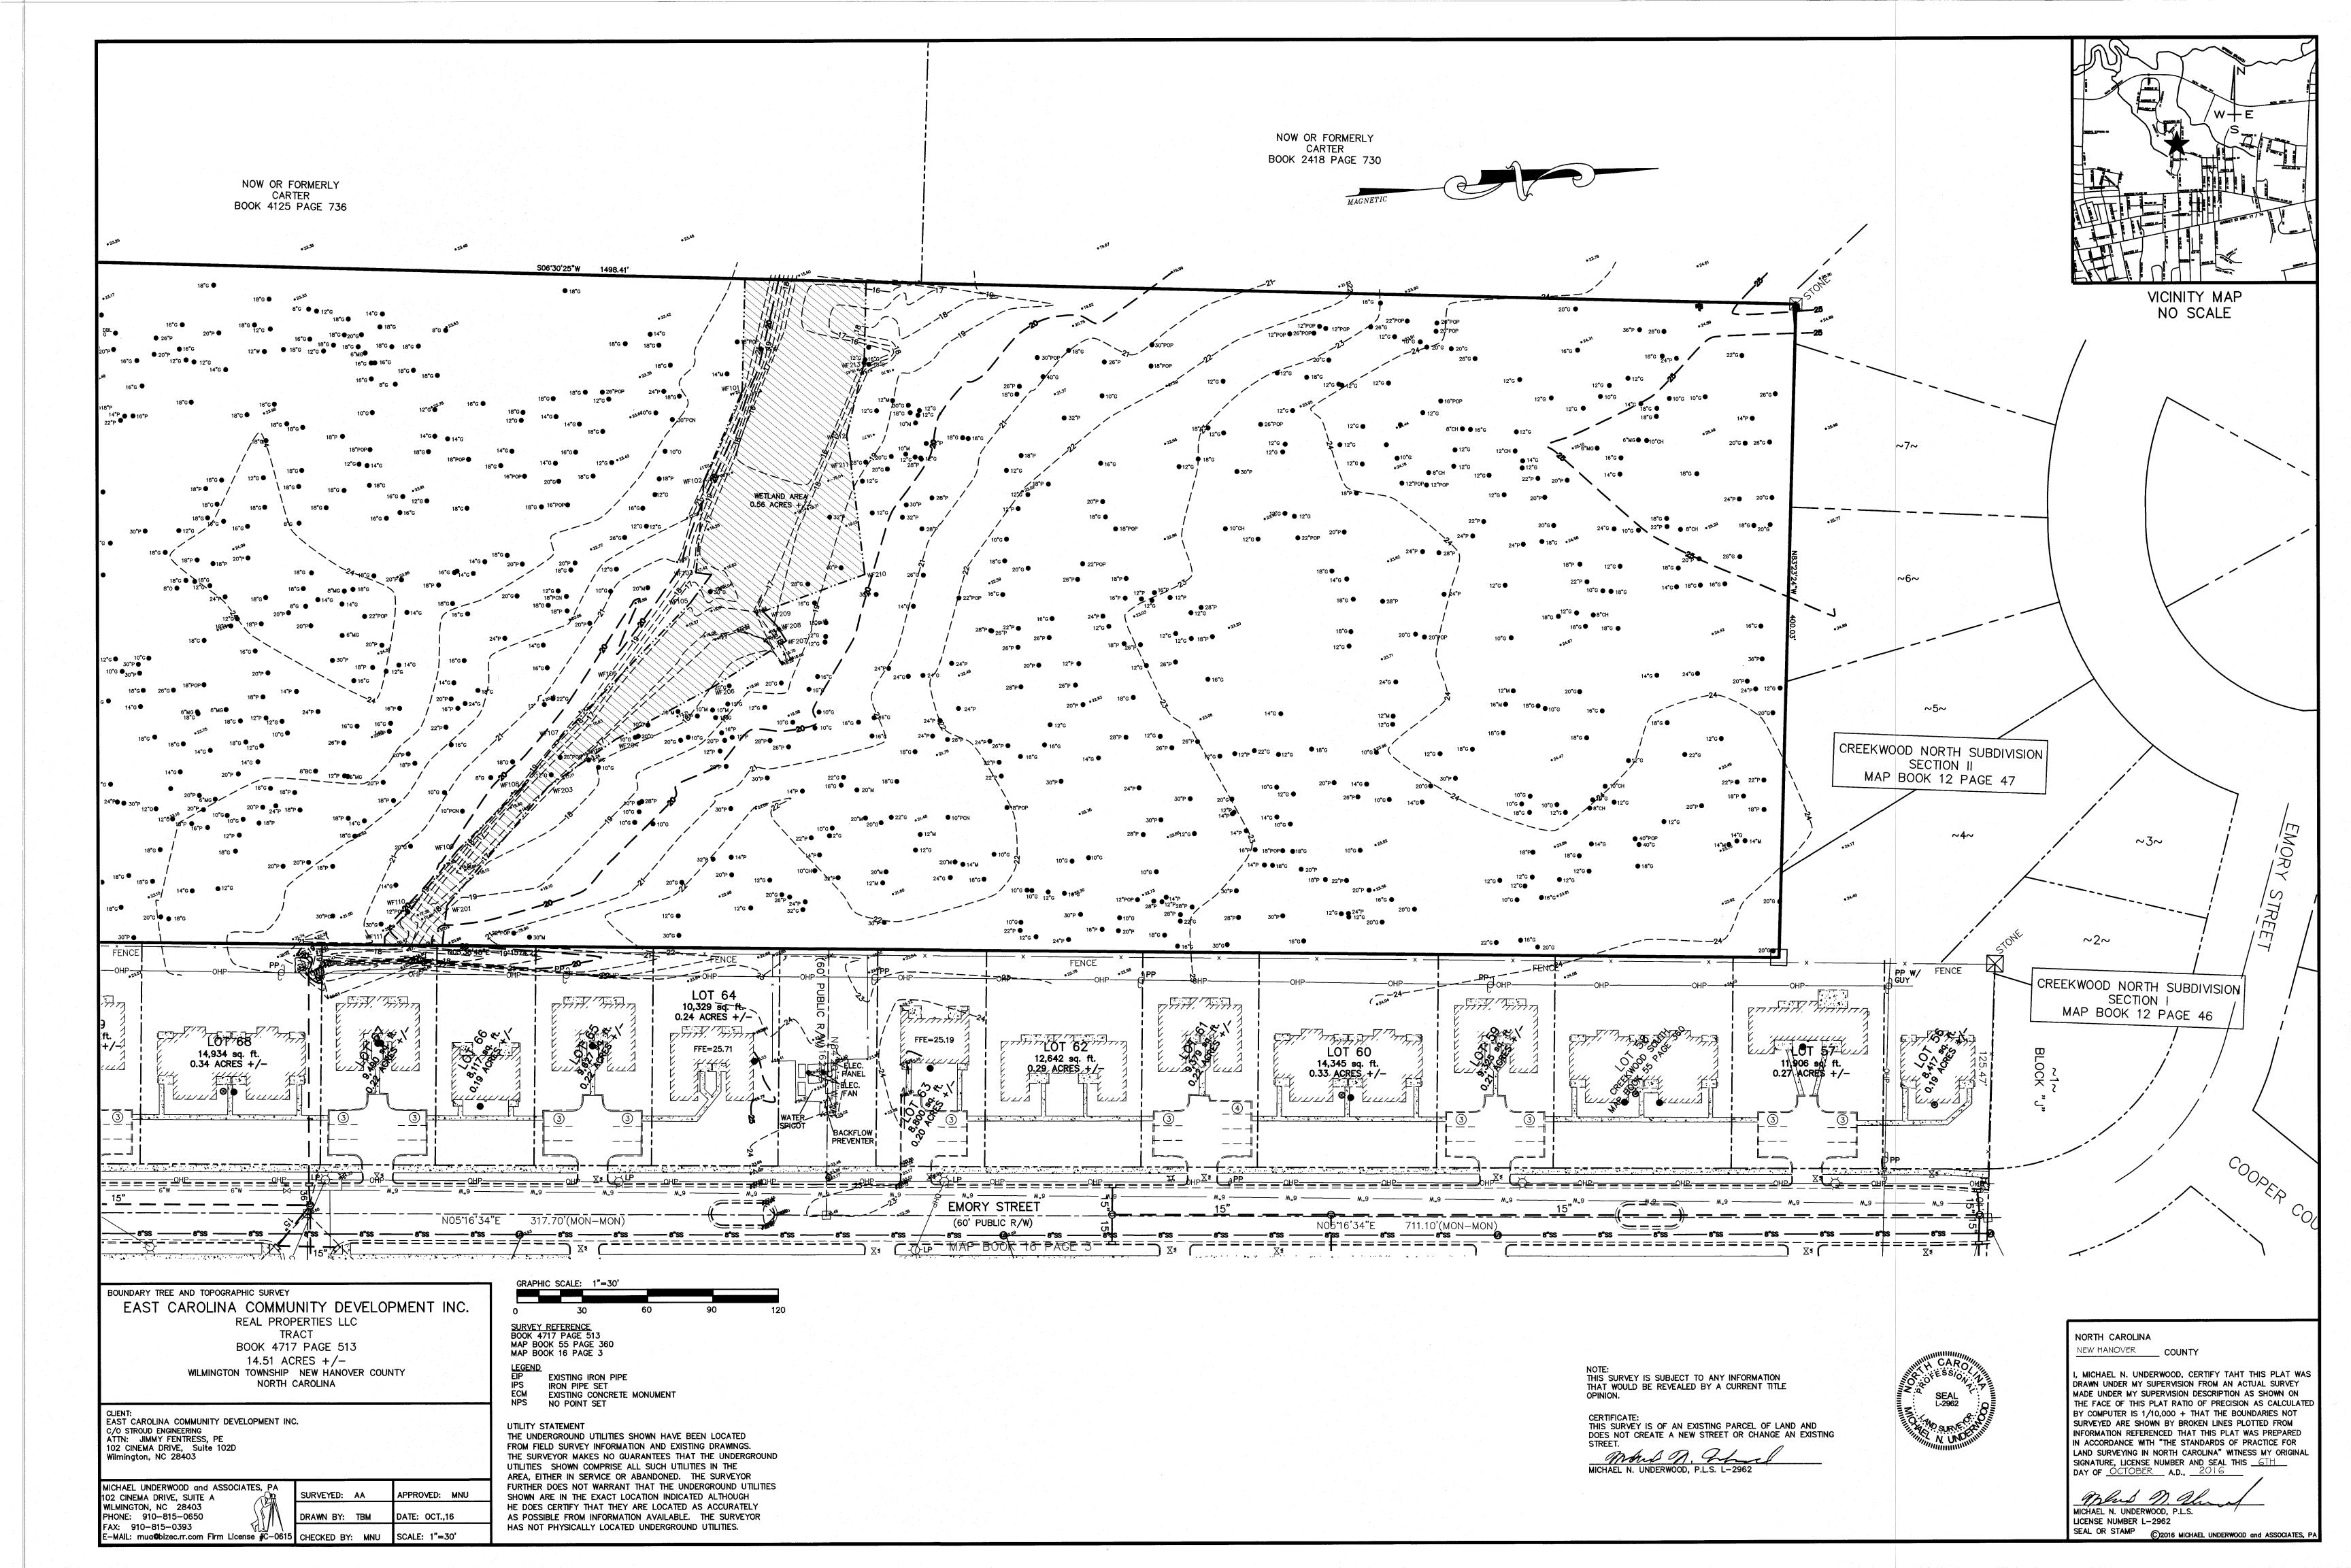

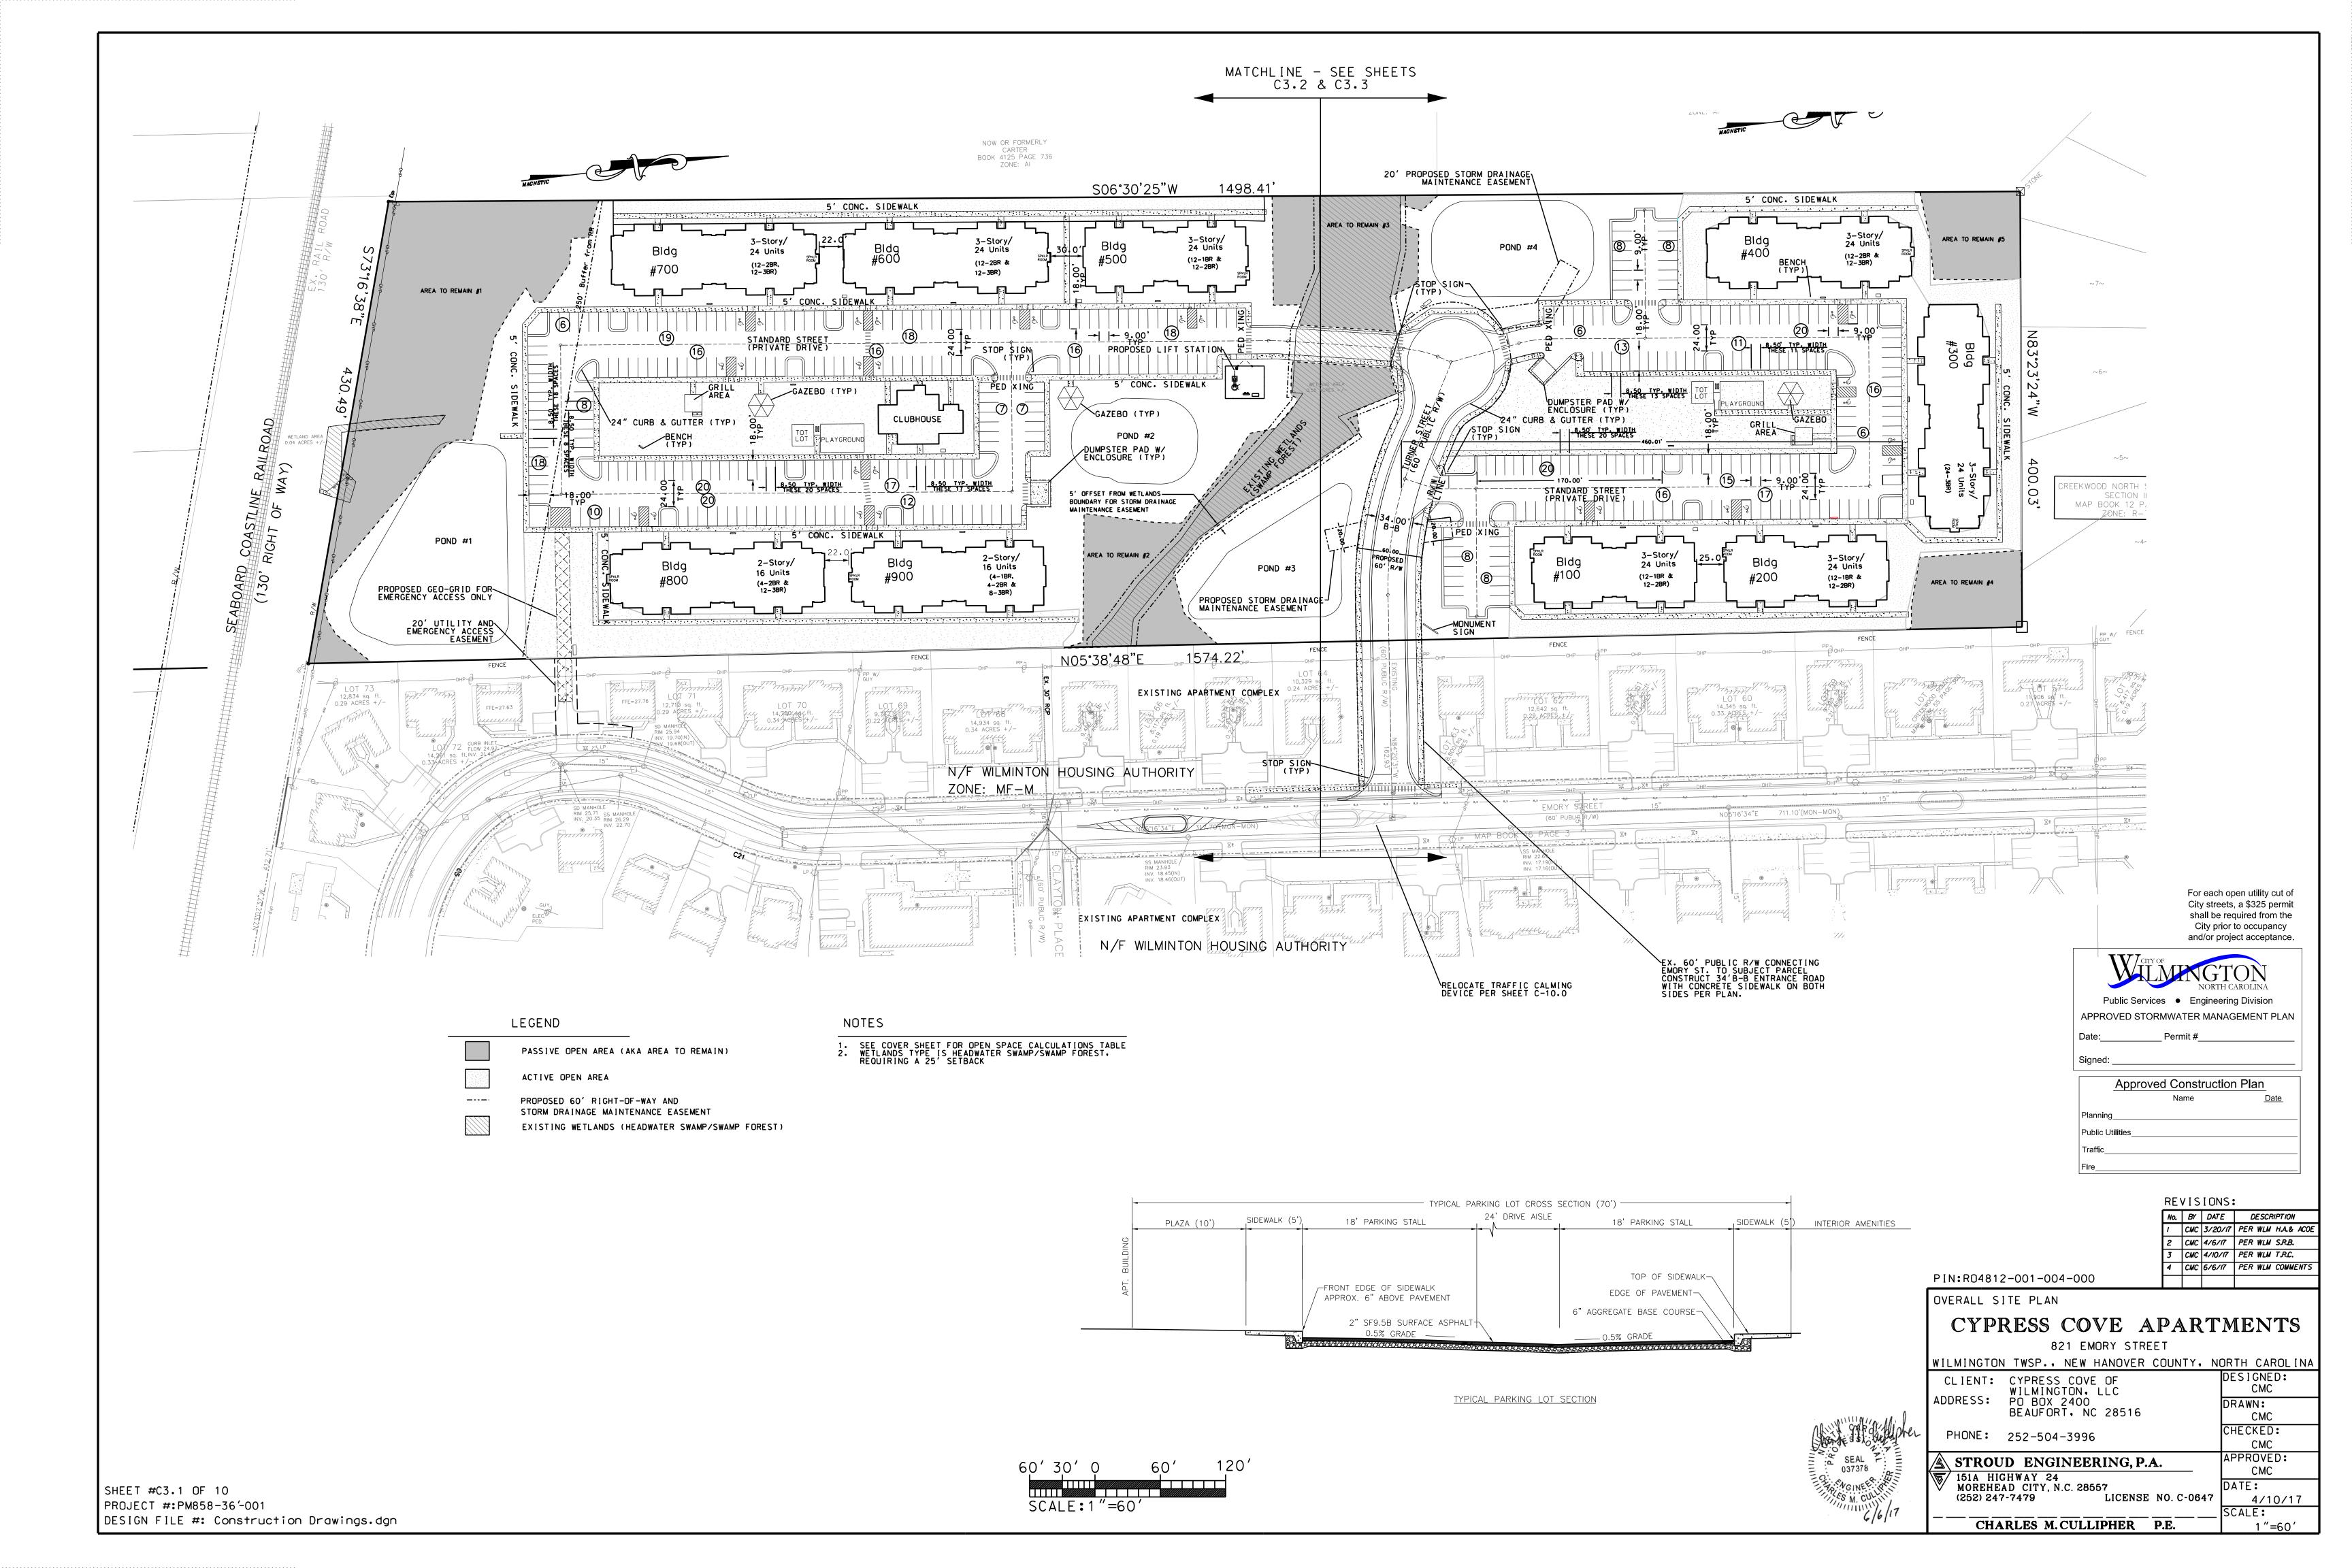

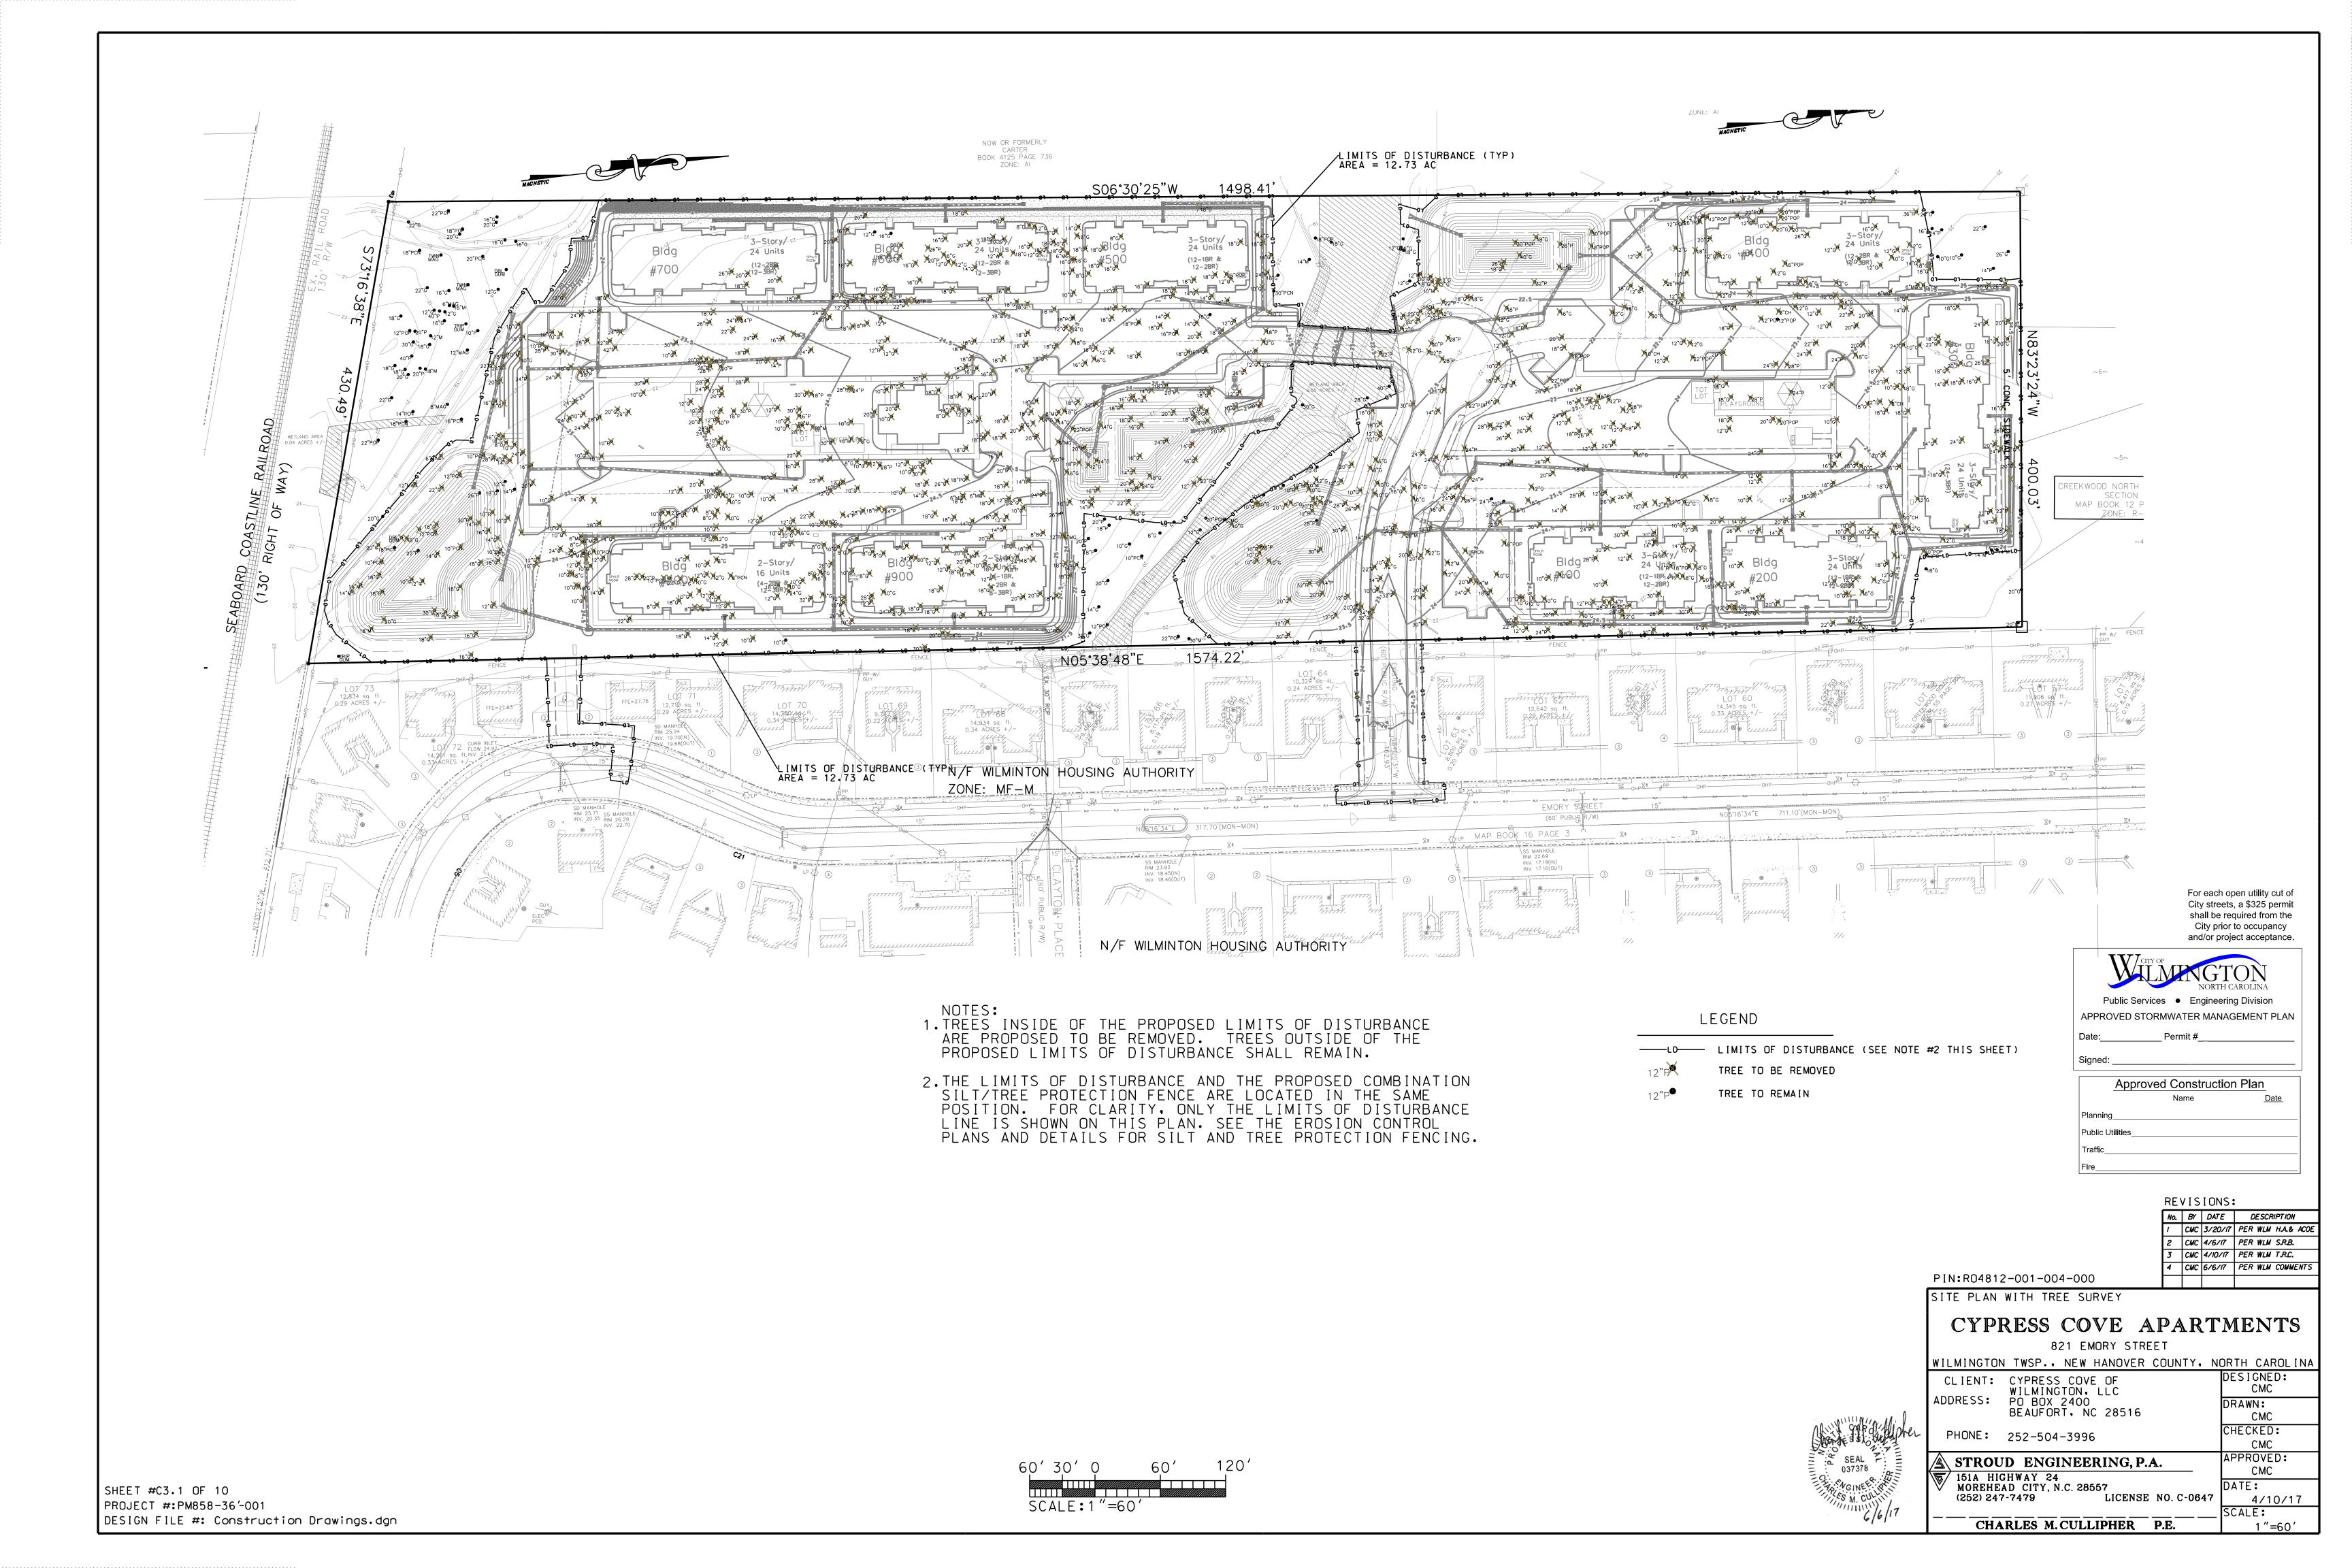

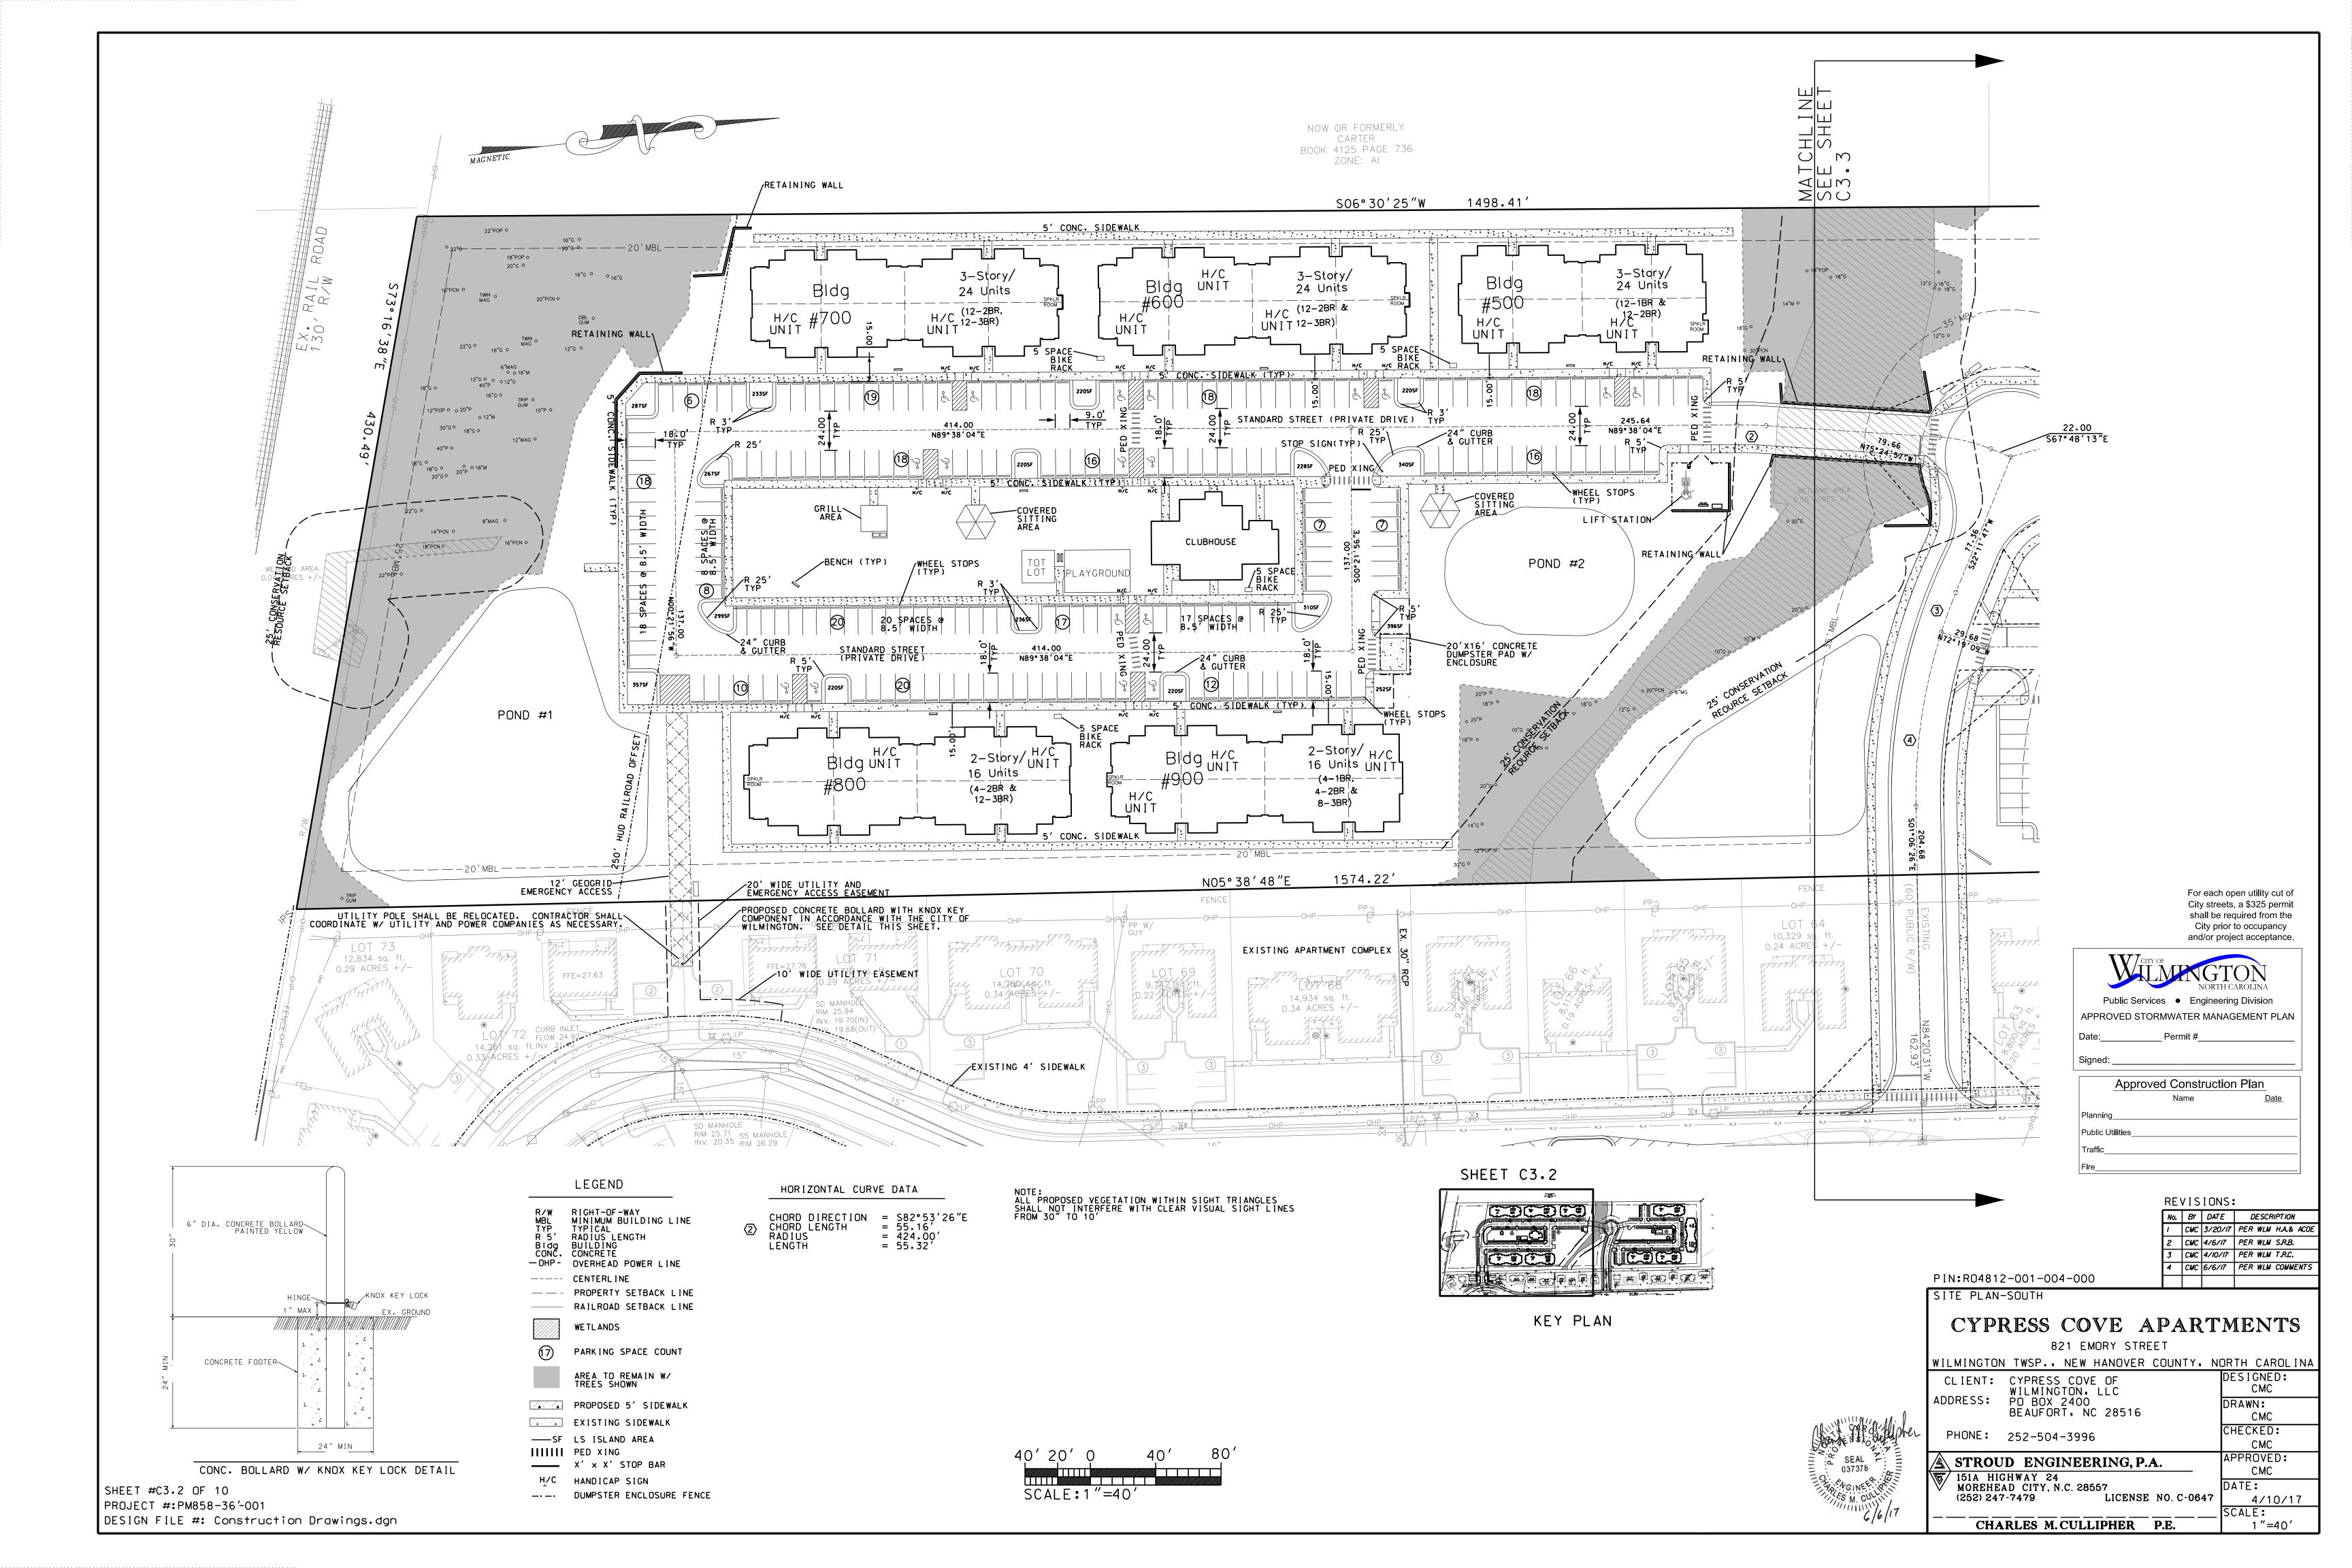

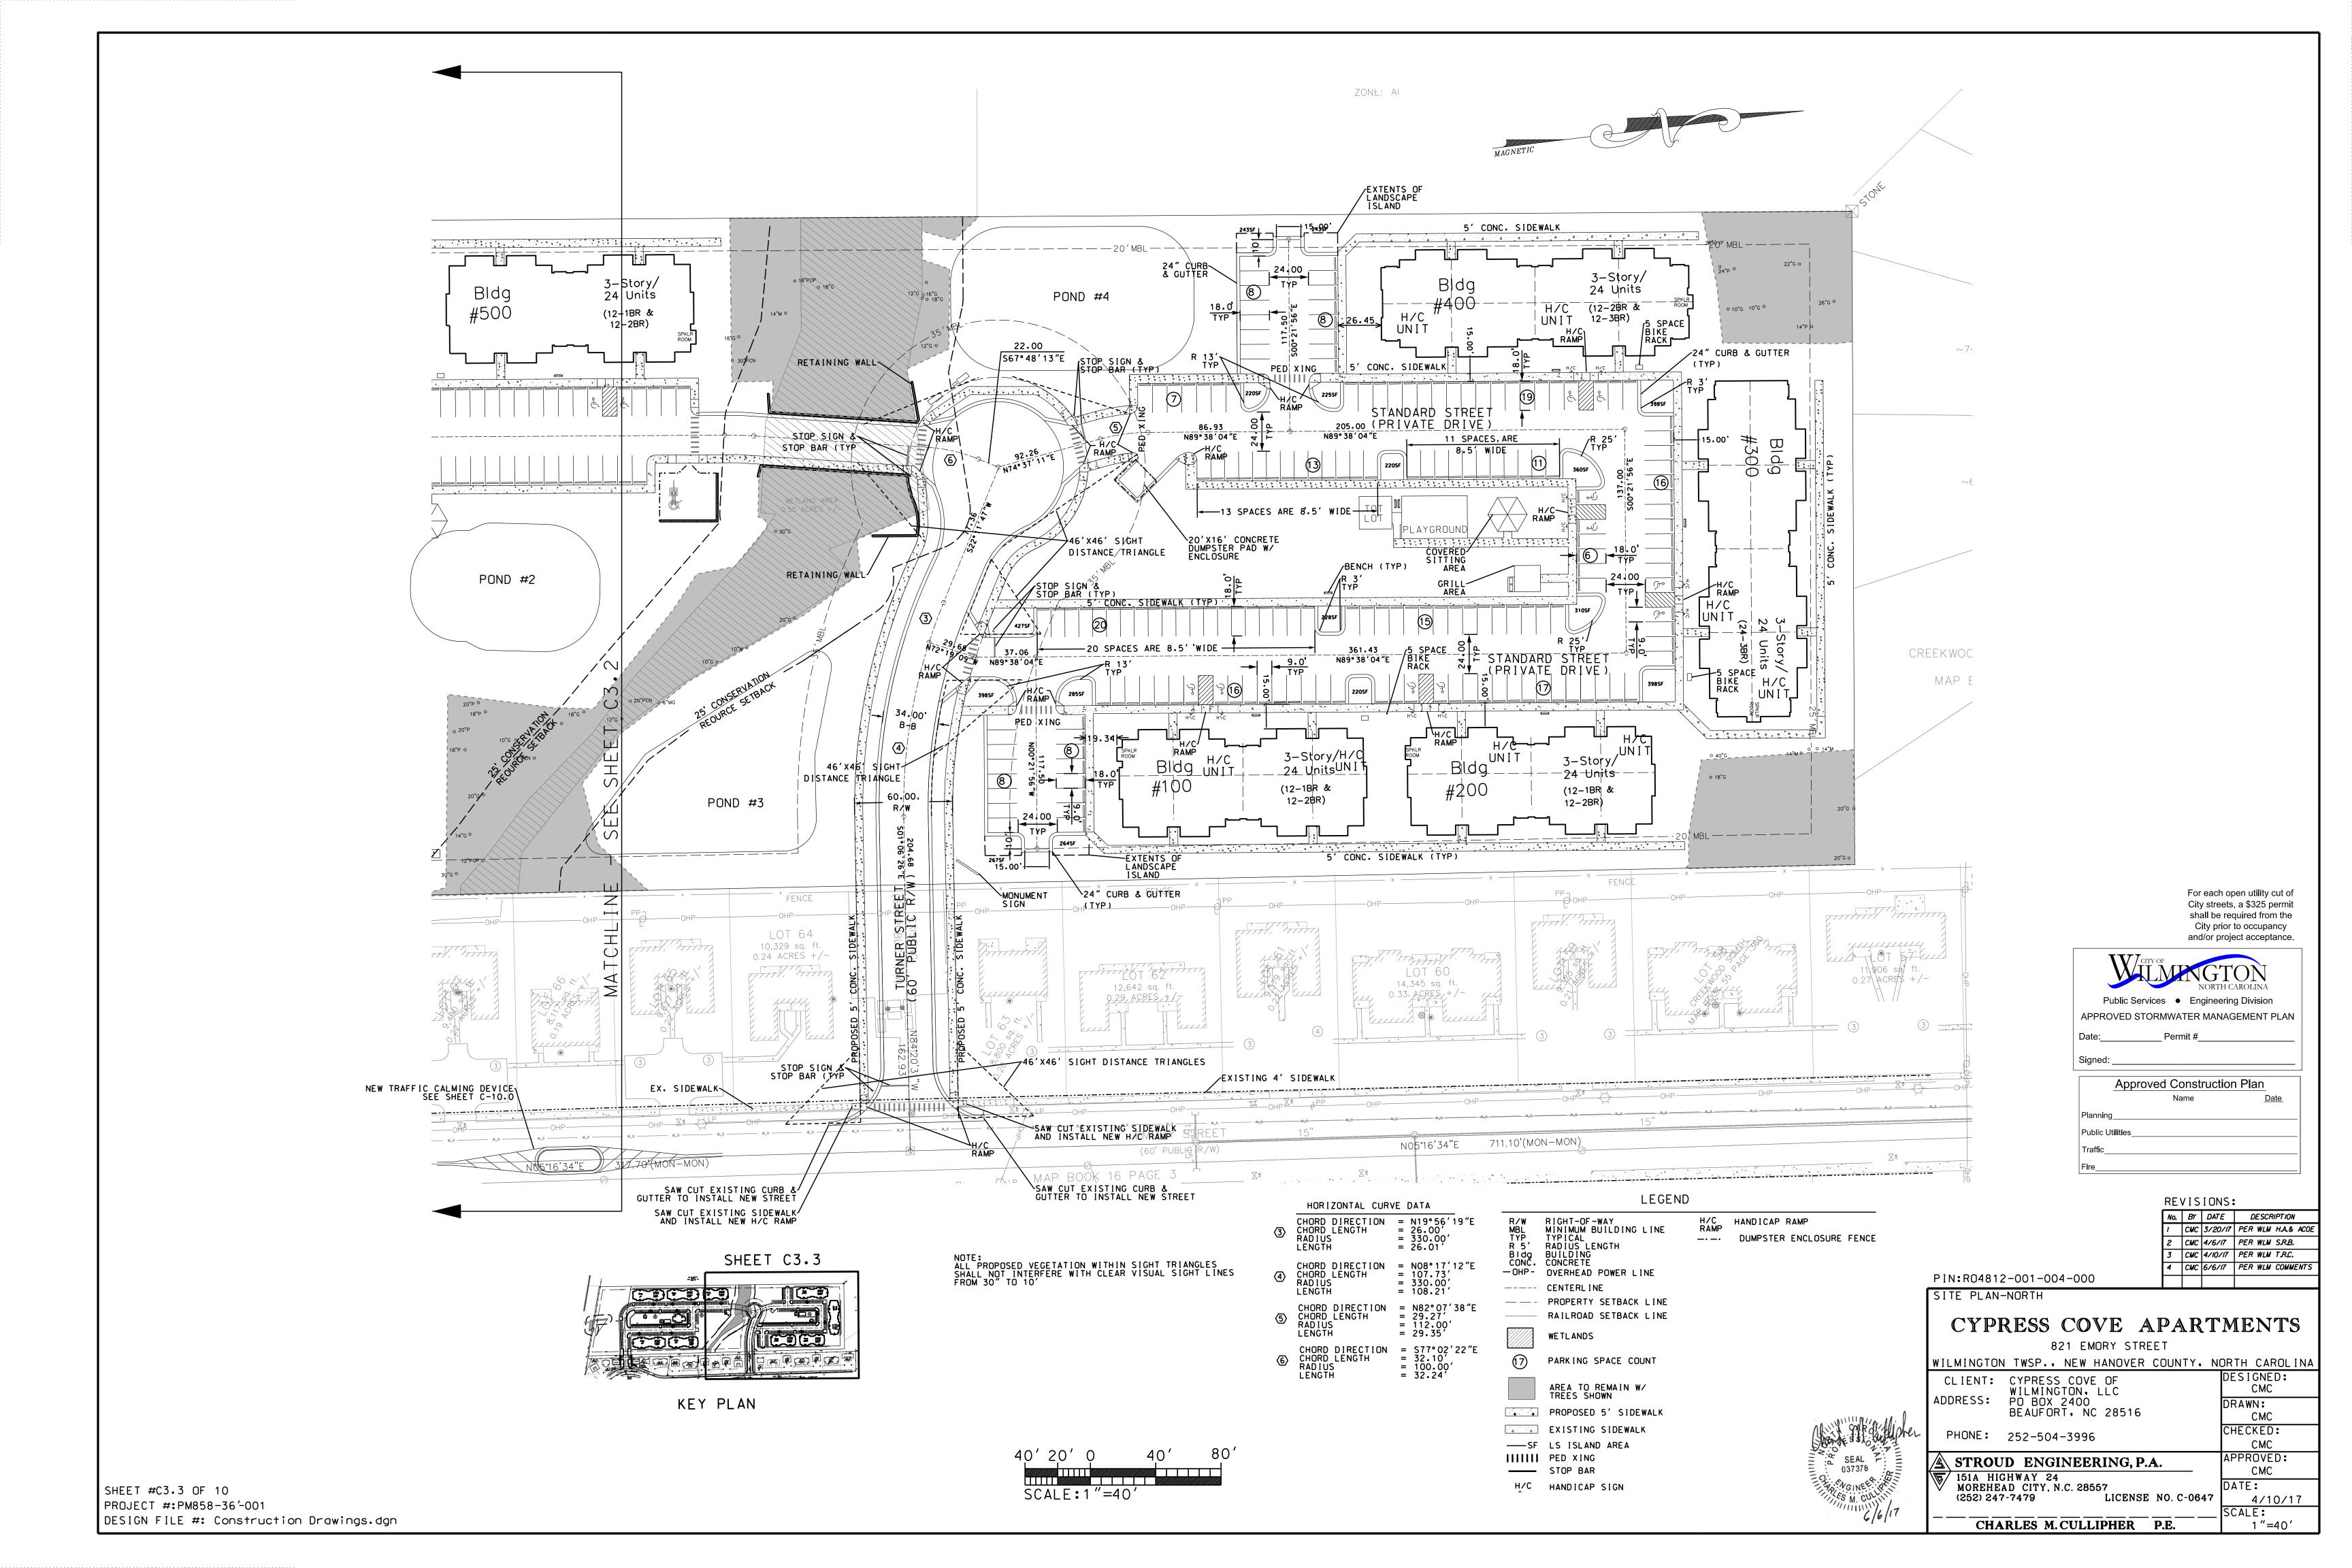

COASTAL PLAIN SITE STABILIZATION SCHEDULE

- Fertilize and lime per recommendations of soil tests or apply 2,000 lb/acre ground agricultural limestone and 750 lb/acre 10-10-10 fertilizer.
 Incorporate lime/fertilizer 4-6 inches.
 Roughen steep slopes by tracked machinary.
- 4. Select species based on season. Refer to tables.
 5. Broadcast seeds evenly and cover by raking or dragging a chain. Firm soil by rolling.
 6. Apply straw mulch at a rate 1-2 tons per acre. Anchor straw by tacking with asphalt, netting, or a mulch anchoring tool.
- A disk with blades set nearly straight can be used as a mulch anchoring tool.

 7. Refertilize if growth is not fully adequate. Reseed, refertilize and mulch immediately following erosion or other daMGe.

PERMANENT SEEDING TABLE 1

Seeding Dates	Recommended Planting	Rate (Ib/ac)
Feb. 15 - Apr. 1 Sep. 1 - Nov. 1	Tall Fescue Mixture	see table 2
Apr. 1 - Aug. 1	Hybrid Bermudagrass	see table 2
Apr. 1 - Jul. 15	Common Bermudagrass	see table 2
Mar. 1 - Jul. 1	Centipedegrass	see table 2

Site Description Recommended Planting Rate (Ib/ac) Well to poorly Tall Fescue Mixture 80

PERMANENT SEEDING TABLE 20-LOW MAINTENANCE MIXTURES

Well to poorly drained soils	Tall Fescue Mixture Pensacola Bahiagrass Kobe Lespedeza	80 50 40
Dry to well drained soils	Pensacola Bahiagrass Common Bermudagrass Kobe Lespedeza German Millet	50 30 10 10
Swales	Common Bermudagrass	40-80

PERMANENT SEEDING TABLE 2b-HIGH MAINTENANCE MIXTURES Site Description Recommended Planting Rate (1b/ac)

3116 DC361 1P11011	precommended i rain ing	Mare Crovaci
Well to poorly	Tall Fescue Mixture	200
drained soils	Rye Grain	25
Dry to well drained soils	Hybrid Bermudagrass	50
Well drained sandy loam to sand, lawns.	Centipedegrass	10-20

Notes:

- For seeding outside of recommended dates and/or for temporary stabilization, refer to temporary seeding table.
- For highly erosive areas or as directed by an engineer, sod shall be provided.


TEMPORARY SEEDING TABLE

Dec. 1 - Apr. 15 Kobe Lespedeza with 50 120 Apr. 15 - Aug. 15 German Millet 40 Aug. 15 - Dec. 1 Rye Grain 120	Seeding Dates	Recommended Planting	Rate (Ib/ac)
,	Dec. 1 - Apr. 15	Kobe Lespedeza with Rye Grain	
Aug. 15 - Dec. 1 Rye Grain 120	Apr. 15 - Aug. 15	German Millet	40
Test in the state of the state	Aug. 15 - Dec. 1	Rye Grain	120

SOD INSTALLATION

- 1. Fertilize and lime per recommendations of soil tests or apply 100 lb/1,000 sf ground agricultural limestone and 25 lb/1,000 sf fertilizer. In the fall, use 10-10-10. In the spring, use 5-10-10.

 2. Incorporate lime/fertilizer 4-6 inches.
- 3. Rake or harrow to achieve a smooth final grade.
 4. Roll to achieve a smooth, firm surface on which
- to lay the sod.
 5. Lightly rake and irrigate top layer of soil just prior to installation.
- 6. Lay sod in a staggered, brick-like pattern with the longest dimension perpendicular to the slope. Avoid gaps. Use a knife to fit irregular shapes.
- Avoid gaps. Use a knife to fit irregular shapes 7. Roll sod lightly after installation to ensure good sod to soil contact.
- 8. Irrigate initially to wet soil to a depth of 4". Keep soil moist for 2-3 weeks thereafter or until sod has taken root.

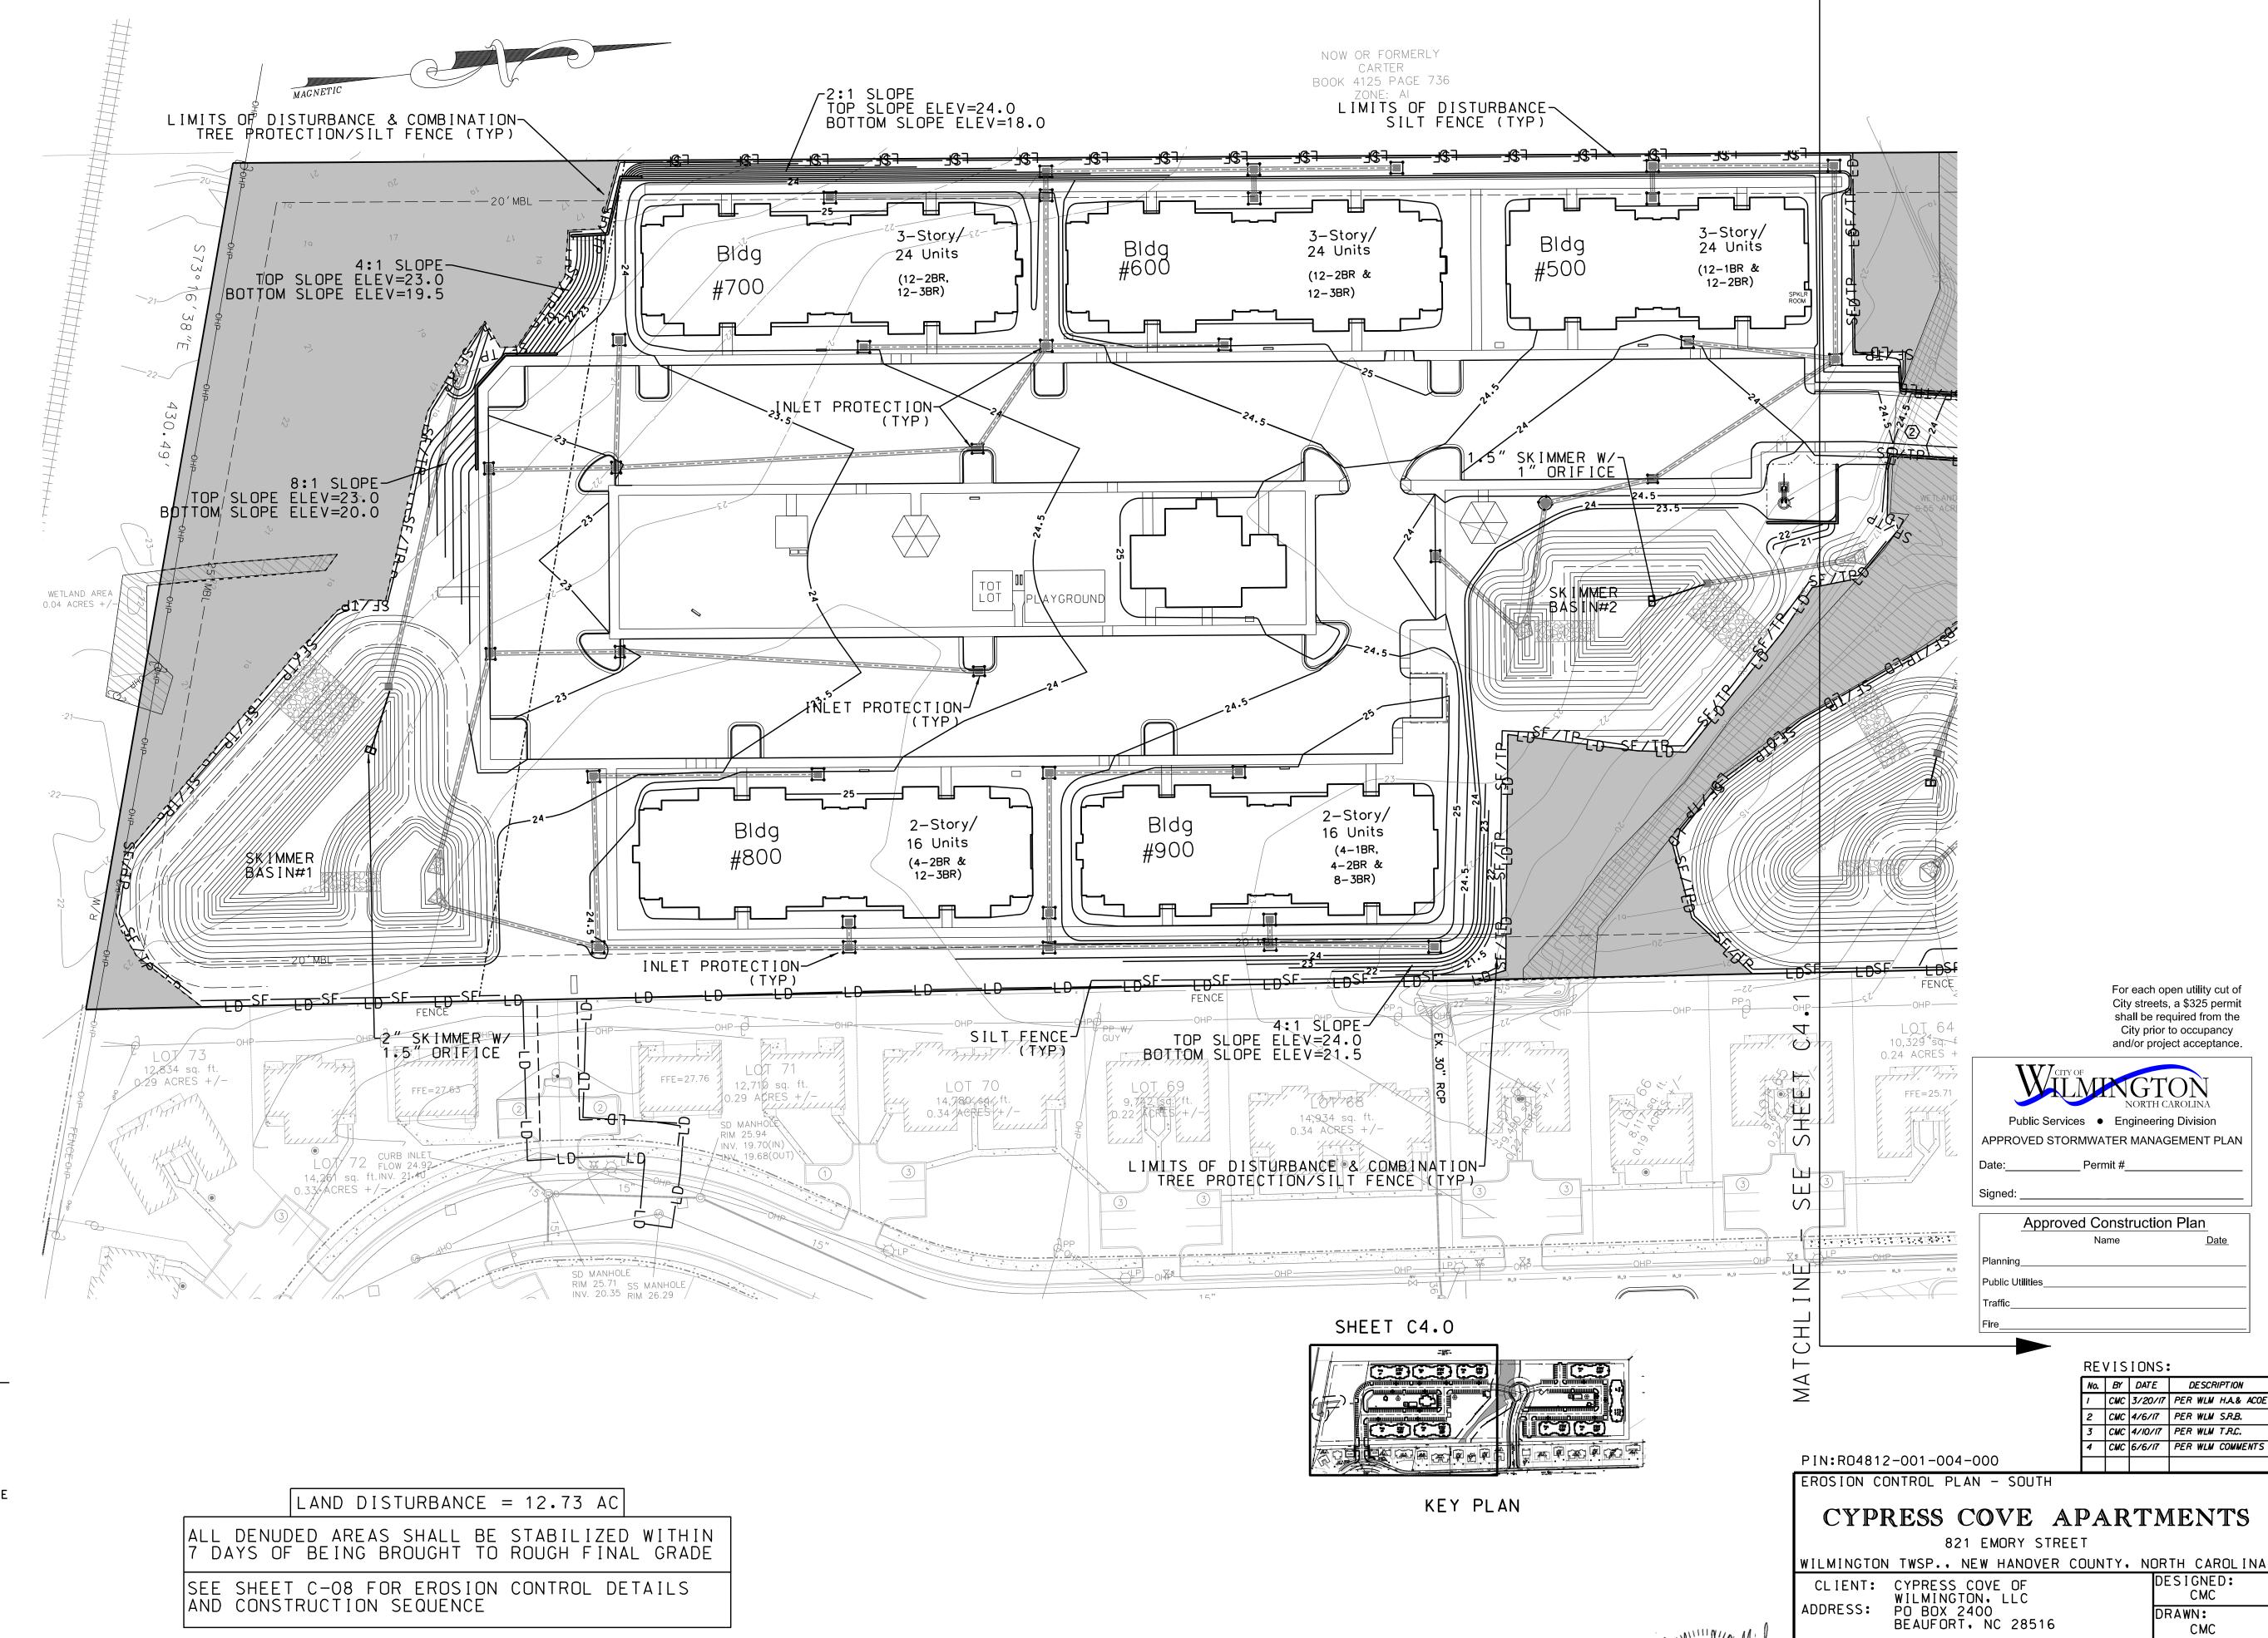

SCALE:1"=40

CHECKED:

CMC

APPROVED:

DATE:

SCALE:

LICENSE NO. C-0647

CMC

4/10/17

1 "=40 '

PHONE: 252-504-3996

MOREHEAD CITY, N.C. 28557

5/ 151A HIGHWAY 24

(252) 247-7479

037378

SONGINEER.

STROUD ENGINEERING, P.A.

CHARLES M. CULLIPHER P.E.

MBL MINIMUM BUILDING LINE

PARKING COUNT

INLET PROTECTION

SF/TP—— PROPOSED COMBINATION TREE PROTECTION & SILT FENCE

PROPOSED SILT FENCE


LIMITS OF DISTURBANCE


404 WETLANDS


LEGEND


PASSIVE OPEN AREA (AKA AREA TO REMAIN)

SHEET #C4.0 OF 10
PROJECT #:PM858-36'-001
DESIGN FILE #: Construction Drawings.dgn

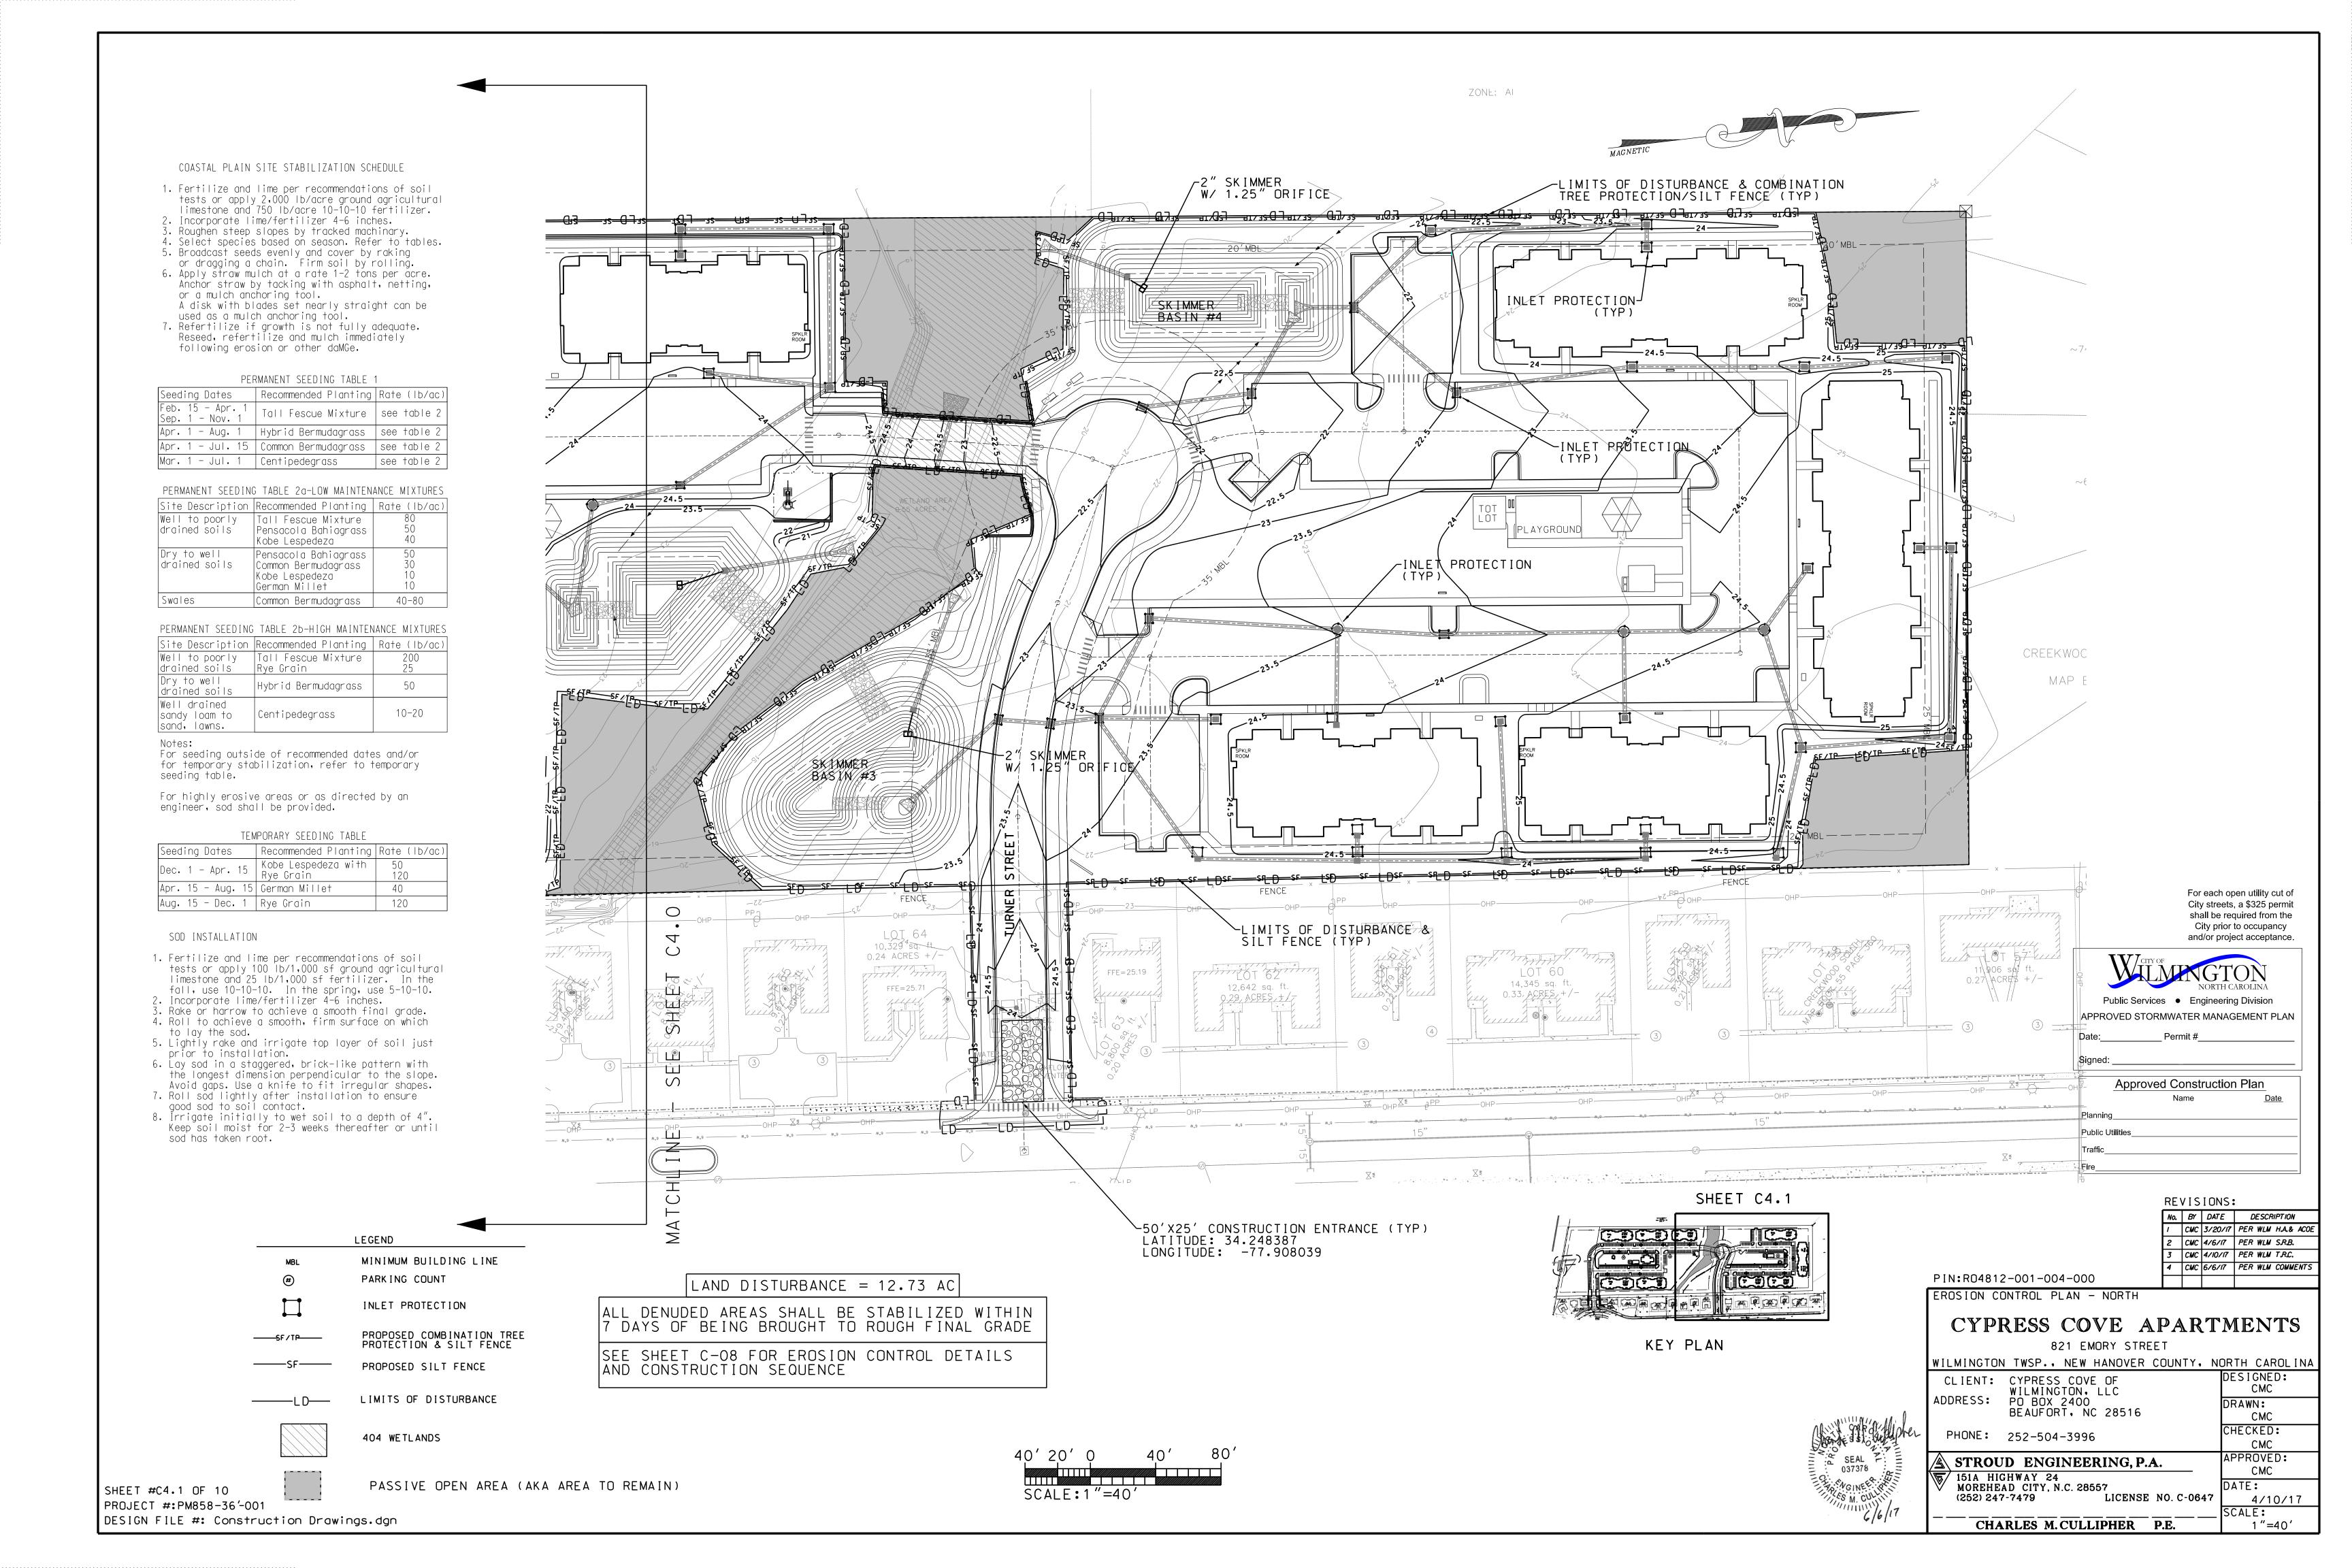

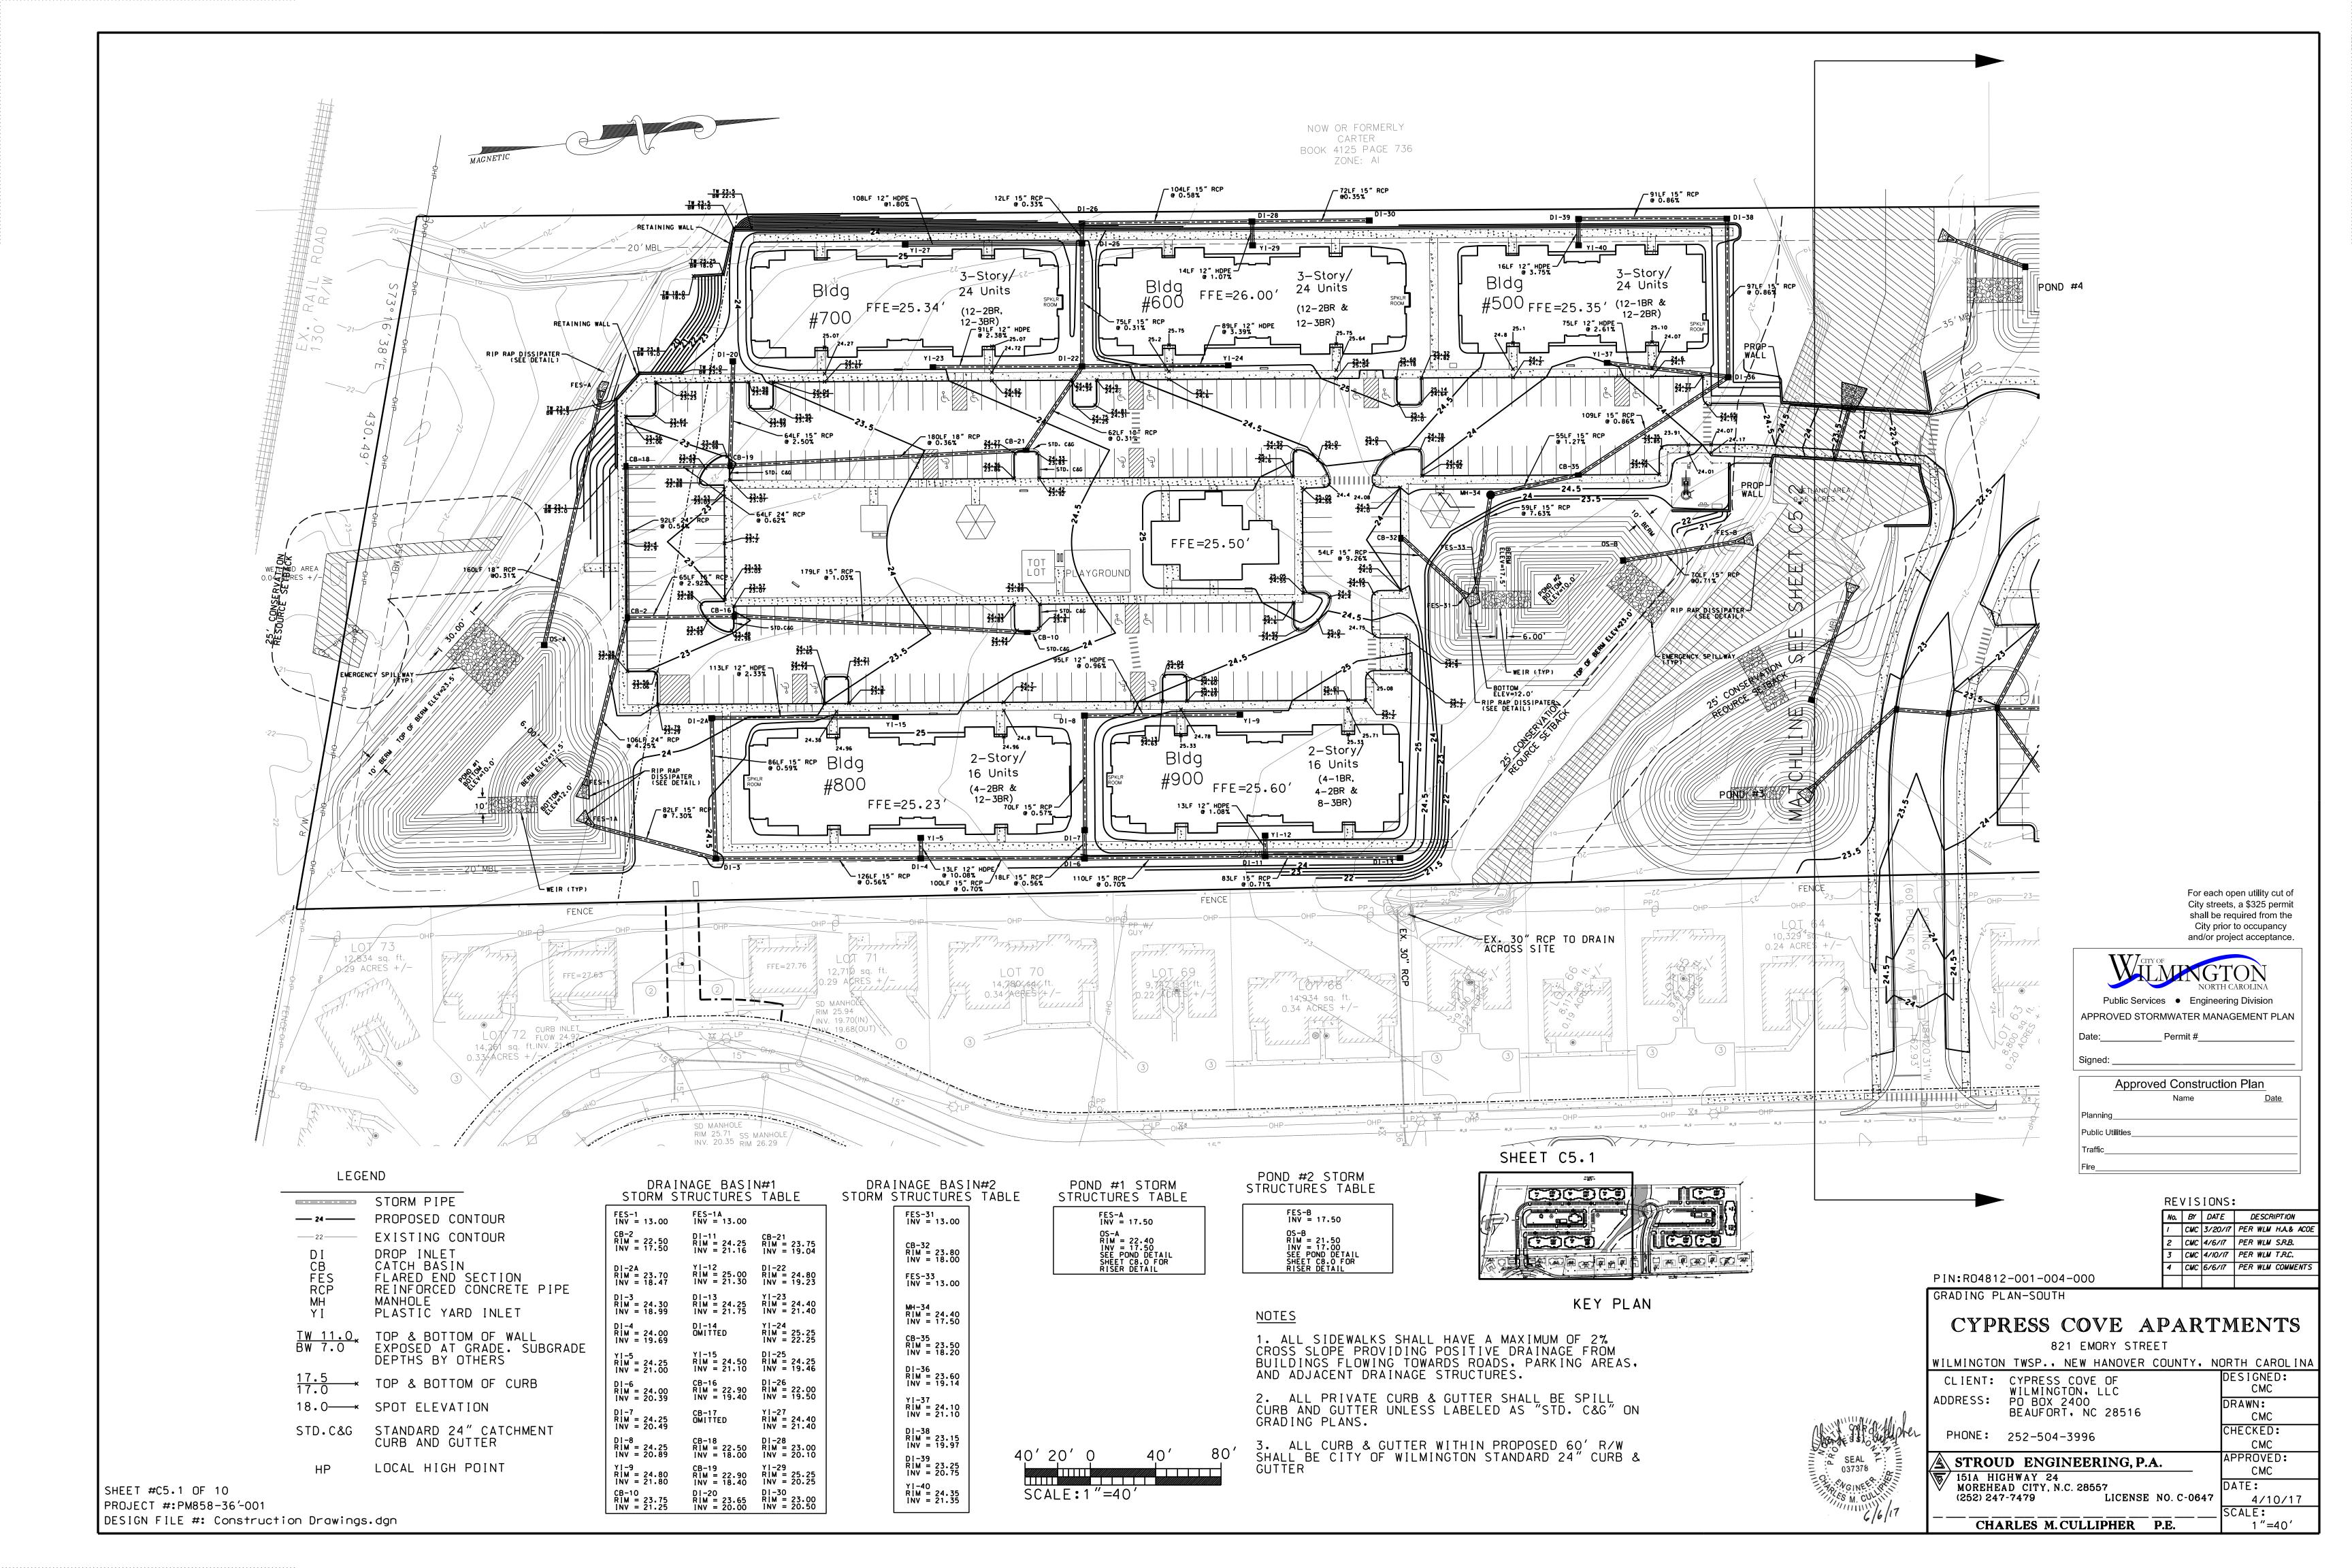

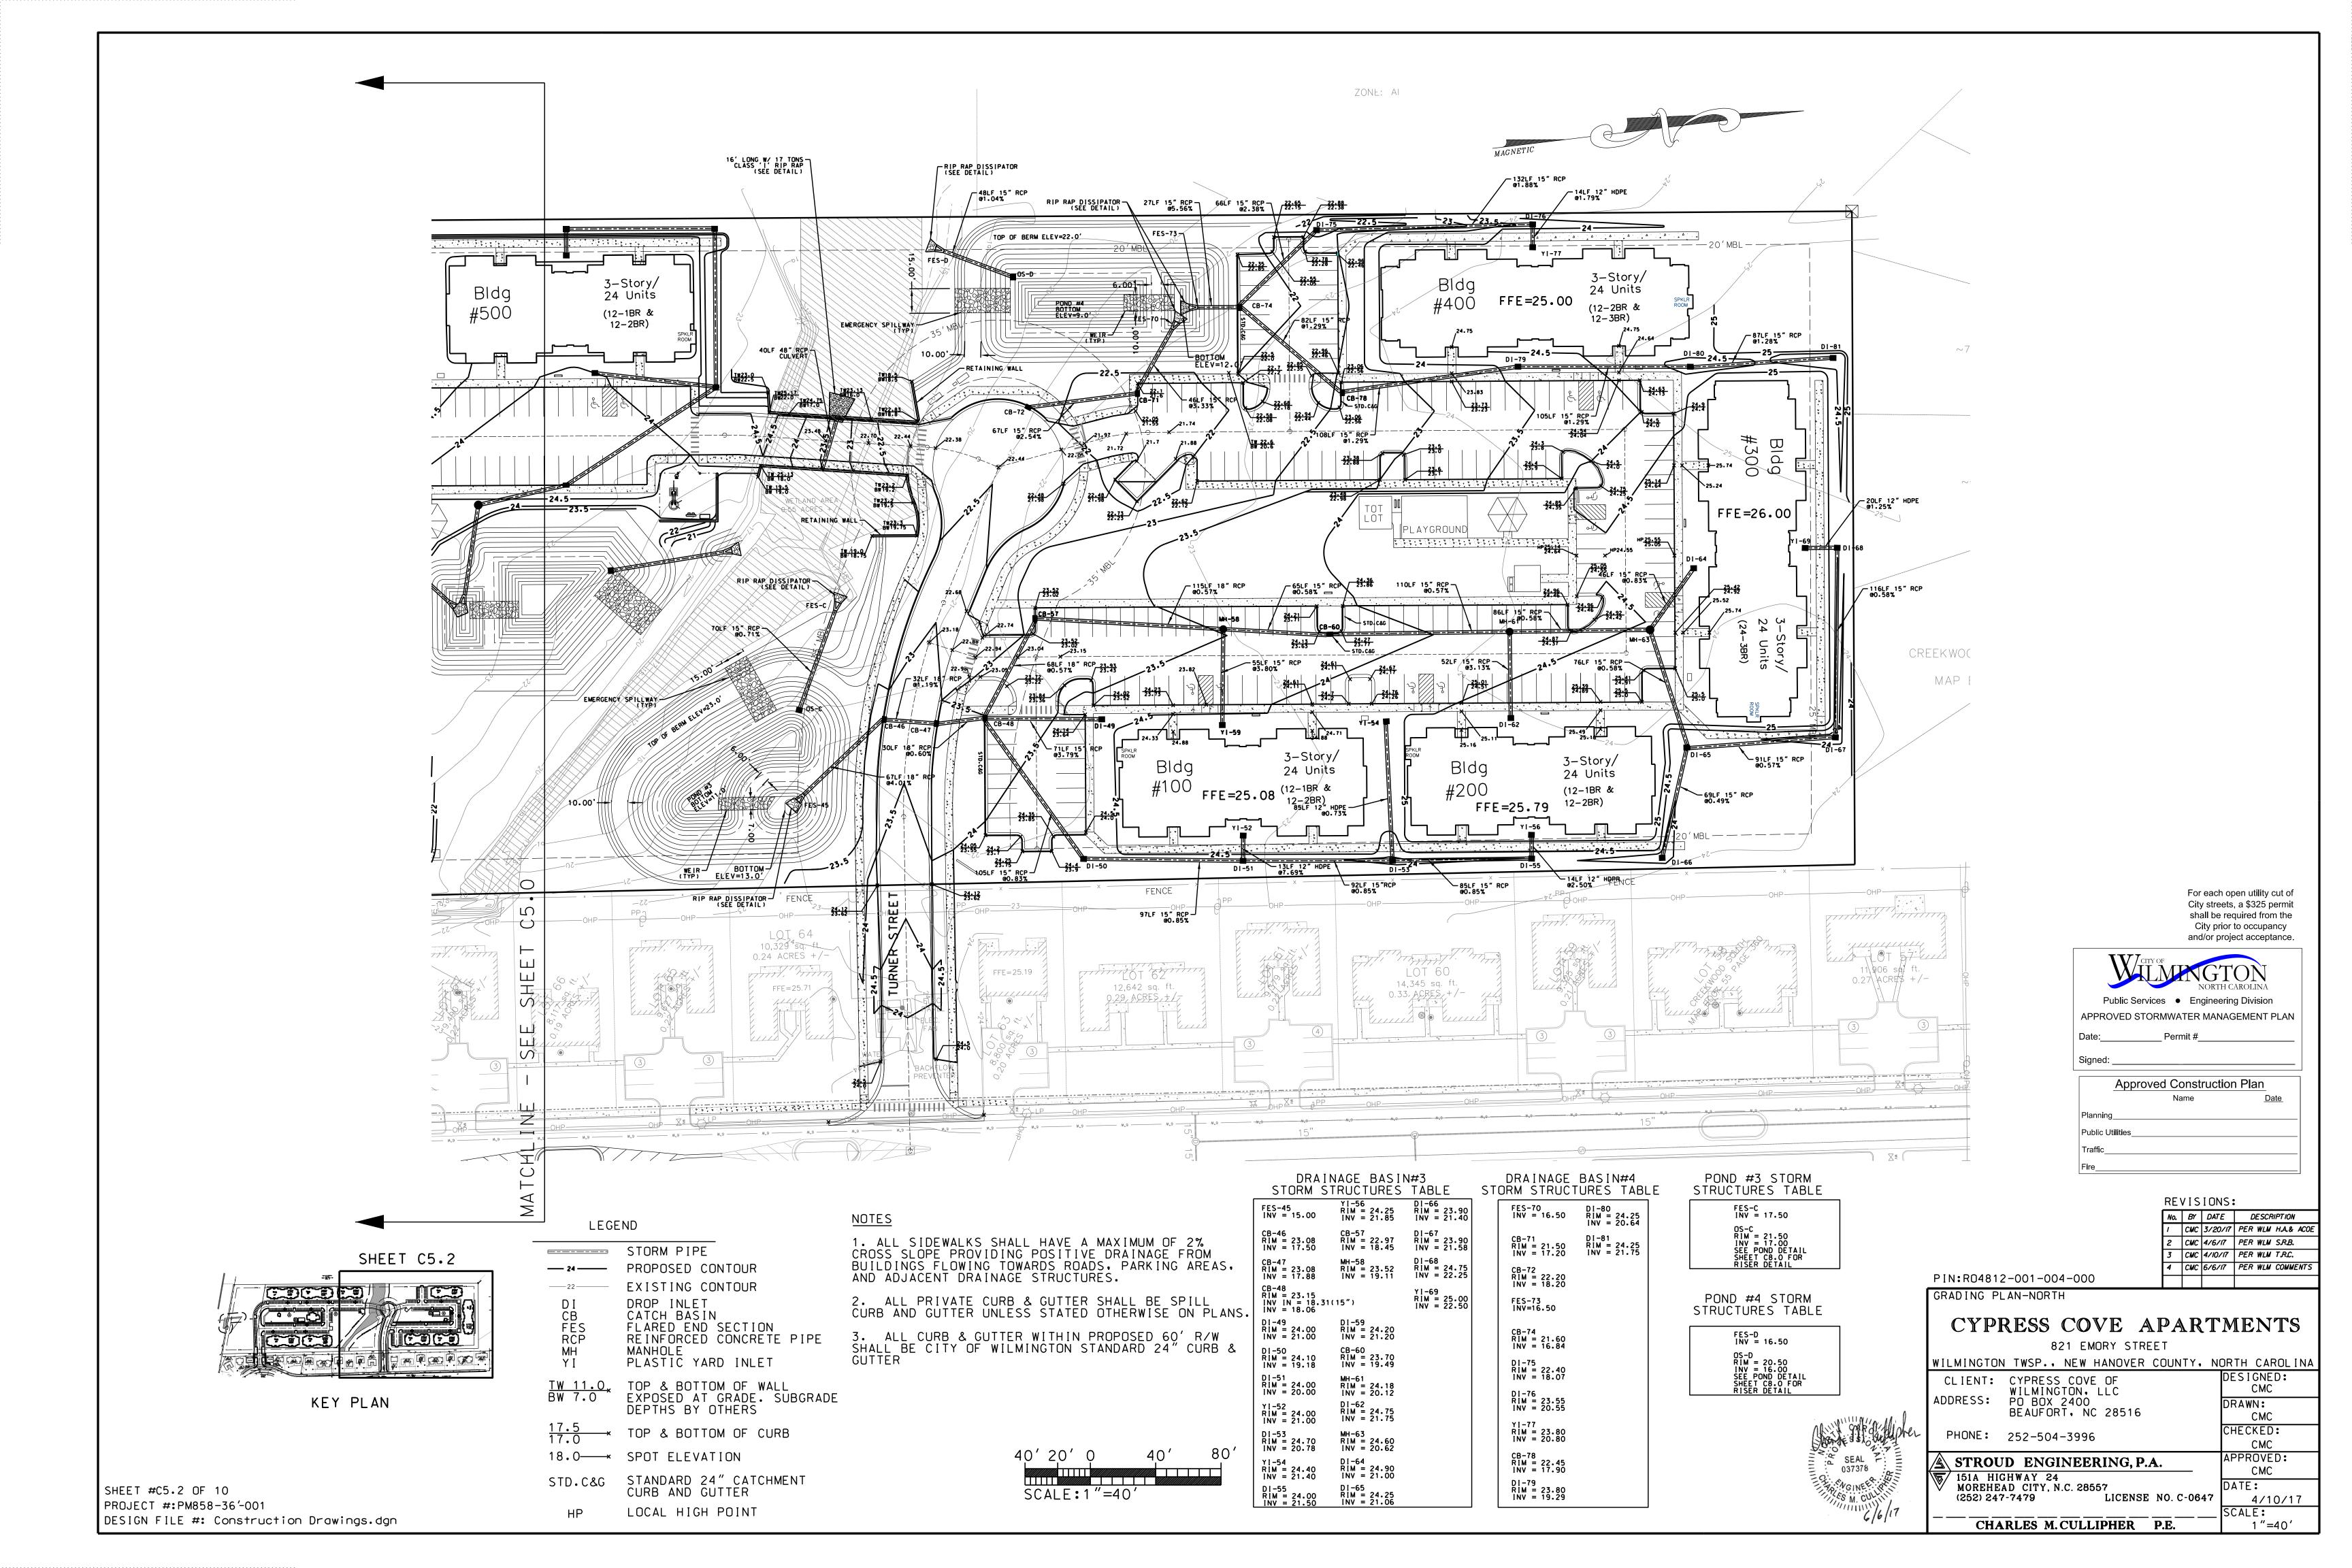

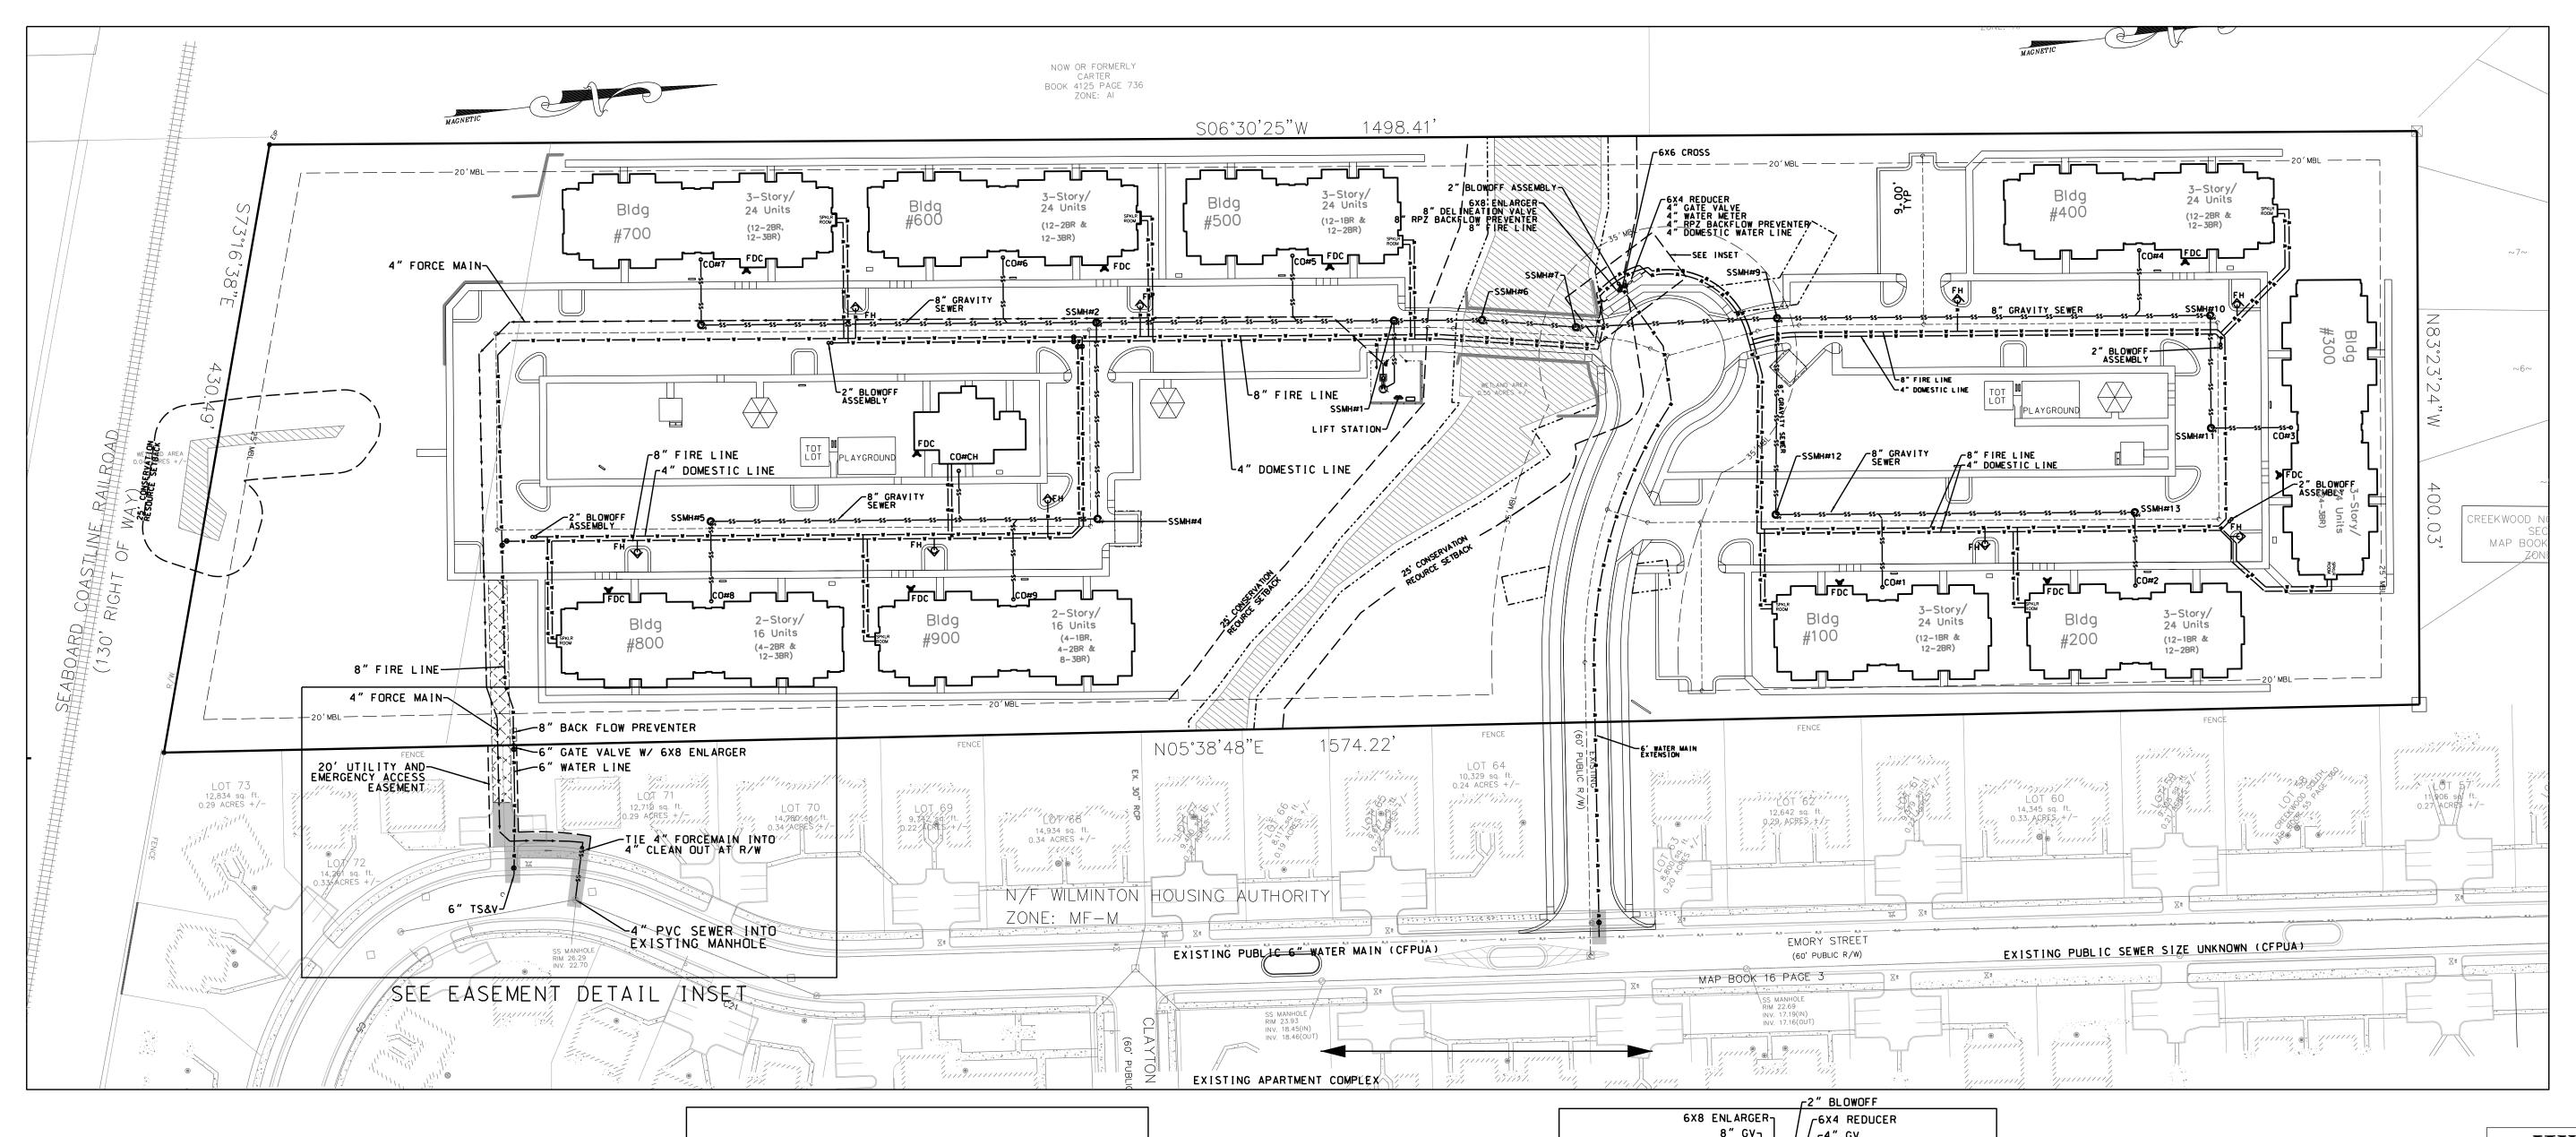

CITY OF WILMINGTON NOTES:

- 1. FIRE HYDRANTS TO BE INSTALLED PER CITY
 OF WILMINGTON ORDINANCE & CFPUA STANDARDS.
 2. PARKING AND LANDSCAPING CANNOT BLOCK FIRE
- HYDRANTS & FDC'S.

 3. FDC'S CANNOT BE FURTHER THAN 40' FROM FIRE DEPARTMENT VEHICLE PLACEMENT.

 4. FDC'S CANNOT BE FURTHER THAN 150' FROM A

- 4. FDC'S CANNOT BE FURTHER THAN 150' FROM A
 FIRE HYDRANT.
 5. ALL BUILDINGS ARE CONSTRUCTION TYPE VB.
 6. ALL HOT BOXES ARE TO BE ELECTRONICALLY SUPERVISED.
 CONTRACTOR SHALL CLOSELY COORDINATE WITH FIRE SPRINKLER
 AND ALARM INSTALLATION SUBCONTRACTOR REGARDING RUNNING
 WIRE FOR THE TAMPER SWITCH TO THE HOTBOX.
 7. IN ADDITION TO STANDARD COMMENTS, ADDITIONAL FIRE
 PROTECTION AND ACCESSIBILITY NEEDS MAY BE REQUIRED
 DUE TO ANY SPECIAL CIRCUMSTANCES CONCERNING THE PROJECT.

PIPE MATERIAL NOTES:


2" WATER MAINS SHALL BE ASTM D2241 SDR 21 CLASS 200 PVC. 6" AND 8" WATER MAINS SHALL BE AWWA C900 DR 18 CLASS 150 PVC. WHERE REQUIRED, DUCTILE IRON WATER SHALL CONFORM TO AWWA C104, C111, C150, C151, AND C153.

GRAVITY SEWER MAINS SHALL BE AWWA C900 DR 18 CLASS 150 PVC. WHERE REQUIRED, DUCTILE IRON SEWER SHALL CONFORM TO AWWA C151. ALL PROPOSED GRAVITY SEWER IS 8 INCHES IN DIAMETER.

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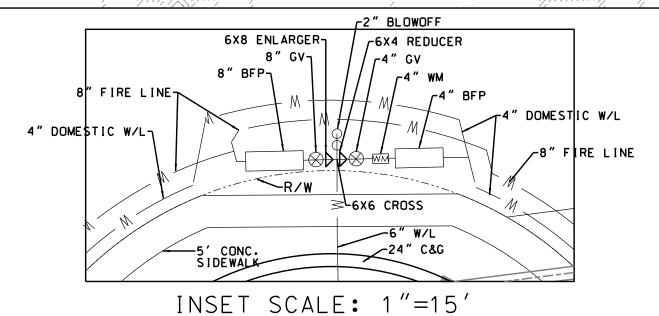
REFER TO PROJECT SPECIFICATIONS FOR ADDITIONAL MATERIAL DETAILS. WHERE A DISCREPANCY OCCURS, THE PROJECT SPECIFICATIONS CONTROL. STORM DRAINS SHALL BE CLASS IV RCP.

PVC WATER MAINS SHALL BE BLUE. DIP WATER MAINS SHALL BE MARKED WITH A CONTINUOUS BLUE STRIPE. PVC SEWER MAINS SHALL BE GREEN. DIP SEWER MAINS SHALL BE MARKED WITH A CONTINUOUS GREEN STRIPE.

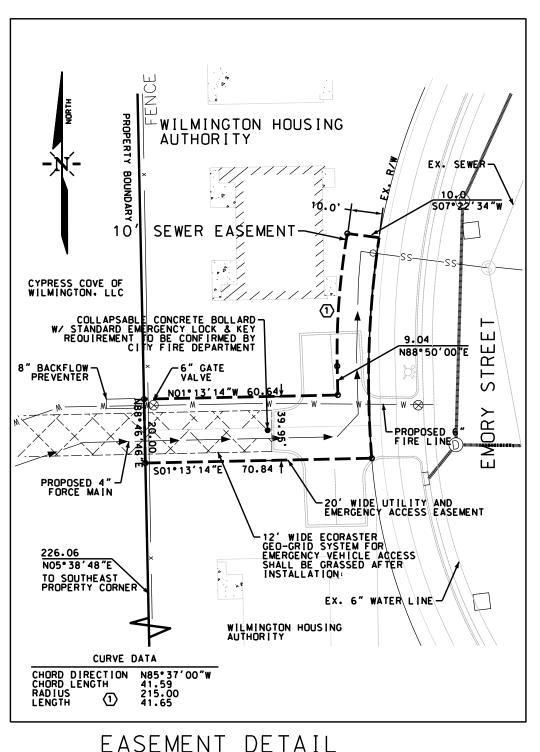

EASEMENT DETAIL INSET SCALE: 1"=30

120 60′ 30' SCALE:1"=60



EXISTING WATER CAPACITY USE PROPOSED WATER CAPACITY USE = 400 GPD PER UNIT X 200 UNITS = 80.000 GPD PLUS CLUBHOUSE AT 400 GPD = 80.400 GPD = 0 GDP

EXISTING SEWER CAPACITY USE PROPOSED SEWER CAPACITY USE = 240 GPD PER 1 & 2 BEDROOM UNITS = 240 GPD X 120 UNITS = 28,800 GPD 360 GPD PER 3 BEDROOM UNITS = 360 GPD X 80 UNITS = 28,800 GPD PLUS CLUBHOUSE AT 240 GDP = 57,840 GPD TOTAL

CAPE FEAR PUBLIC UTILITY AUTHORITY STANDARD SEWER NOTES:

WATER AND SEWER CAPACITIES

- SEWER GUARDS REQUIRED AT ALL MANHOLES. STAINLESS STEEL
 SEWER GUARDS REQUIRED AT MANHOLES LOCATED IN TRAFFIC AREAS.
 SERVICES SHALL BE PERPENDICULAR TO MAIN AND TERMINATE AT
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 ALL SERVICES TYING INTO DUCTILE IRON MAINS SHALL BE CONSTRUCTED
 OF CLASS 50 DIP WITH PROTECTO 401 CERAMIC EPOXY LINING.
 MINIMUM 10' UTILITIES EASEMENT PROVIDED ALONG THE FRONTAGE OF
 ALL LOTS AND AS SHOWN FOR NEW DEVELOPMENTS.
 NO FLEXIBLE COUPLINGS SHALL BE USED.
 ALL STAINLESS STEEL FASTENERS SHALL BE 316.

OWNERSHIP NOTE:

ALL PROPOSED UTILITIES ARE PROPOSED AS PRIVATE WITH THE EXCEPTION TO UTILITIES PROPOSED IN THE PROPOSED RIGHT-OF-WAY OF CYPRESS COVE LANE AND THE ASSOCIATED CONNECTIONS WITHIN THE EXISTING EMORY STREET RIGHT-OF-WAY. UTILITIES WITHIN THE EXISTING AND PROPOSED RIGHT-OF-WAYS SHALL BE CONSIDERED PUBLIC.

LEGEND

PROPOSED STORM DRAINAGE ——SS— PROPOSED SANITARY SEWER ── W ── PROPOSED WATER

> PROPOSED FIRE HYDRANT PROPOSED FORCE MAIN PROPOSED CLEAN OUT

PROPOSED SANITARY SEWER MANHOLE PROPOSED CENTERLINE

PROPOSED OPEN CUT ASPHALT/CONCRETE REPAIR PROPOSED FIRE DEPARTMENT

CONNECTION

SEAL

037378

NOINE LA PA

Public Services • Engineering Division APPROVED STORMWATER MANAGEMENT PLAN Permit # Approved Construction Plan

REVISIONS:

No.	BY	DATE	DESCRIPTION
1	CMC	3/20/17	PER WLM H.A.& ACOE
2	CMC	4/6/17	PER WLM S.R.B.
3	CMC	4/10/17	PER WLM T.R.C.
4	CMC	6/6/17	PER WLM COMMENTS

DESIGNED:

DRAWN:

DATE:

CMC

CMC

CMC

APPROVED:

CMC

4/10/17

CHECKED:

For each open utility cut of City streets, a \$325 permit

shall be required from the City prior to occupancy

and/or project acceptance

PIN:R04812-001-004-000

OVERALL UTILITY PLAN CYPRESS COVE APARTMENTS

821 EMORY STREET

WILMINGTON TWSP., NEW HANOVER COUNTY, NORTH CAROLINA CLIENT: CYPRESS COVE OF WILMINGTON, LLC PO BOX 2400 BEAUFORT, NC 28516

PHONE: 252-504-3996


STROUD ENGINEERING, P.A.


151A HIGHWAY 24 MOREHEAD CITY, N.C. 28557


(252) 247-7479 LICENSE NO. C-0647 SCALE: 1 "=60 '

CHARLES M. CULLIPHER P.E.


SHEET #C6.0 OF 10 PROJECT #:PM858-36'-001 DESIGN FILE #: Construction Drawings.dgn

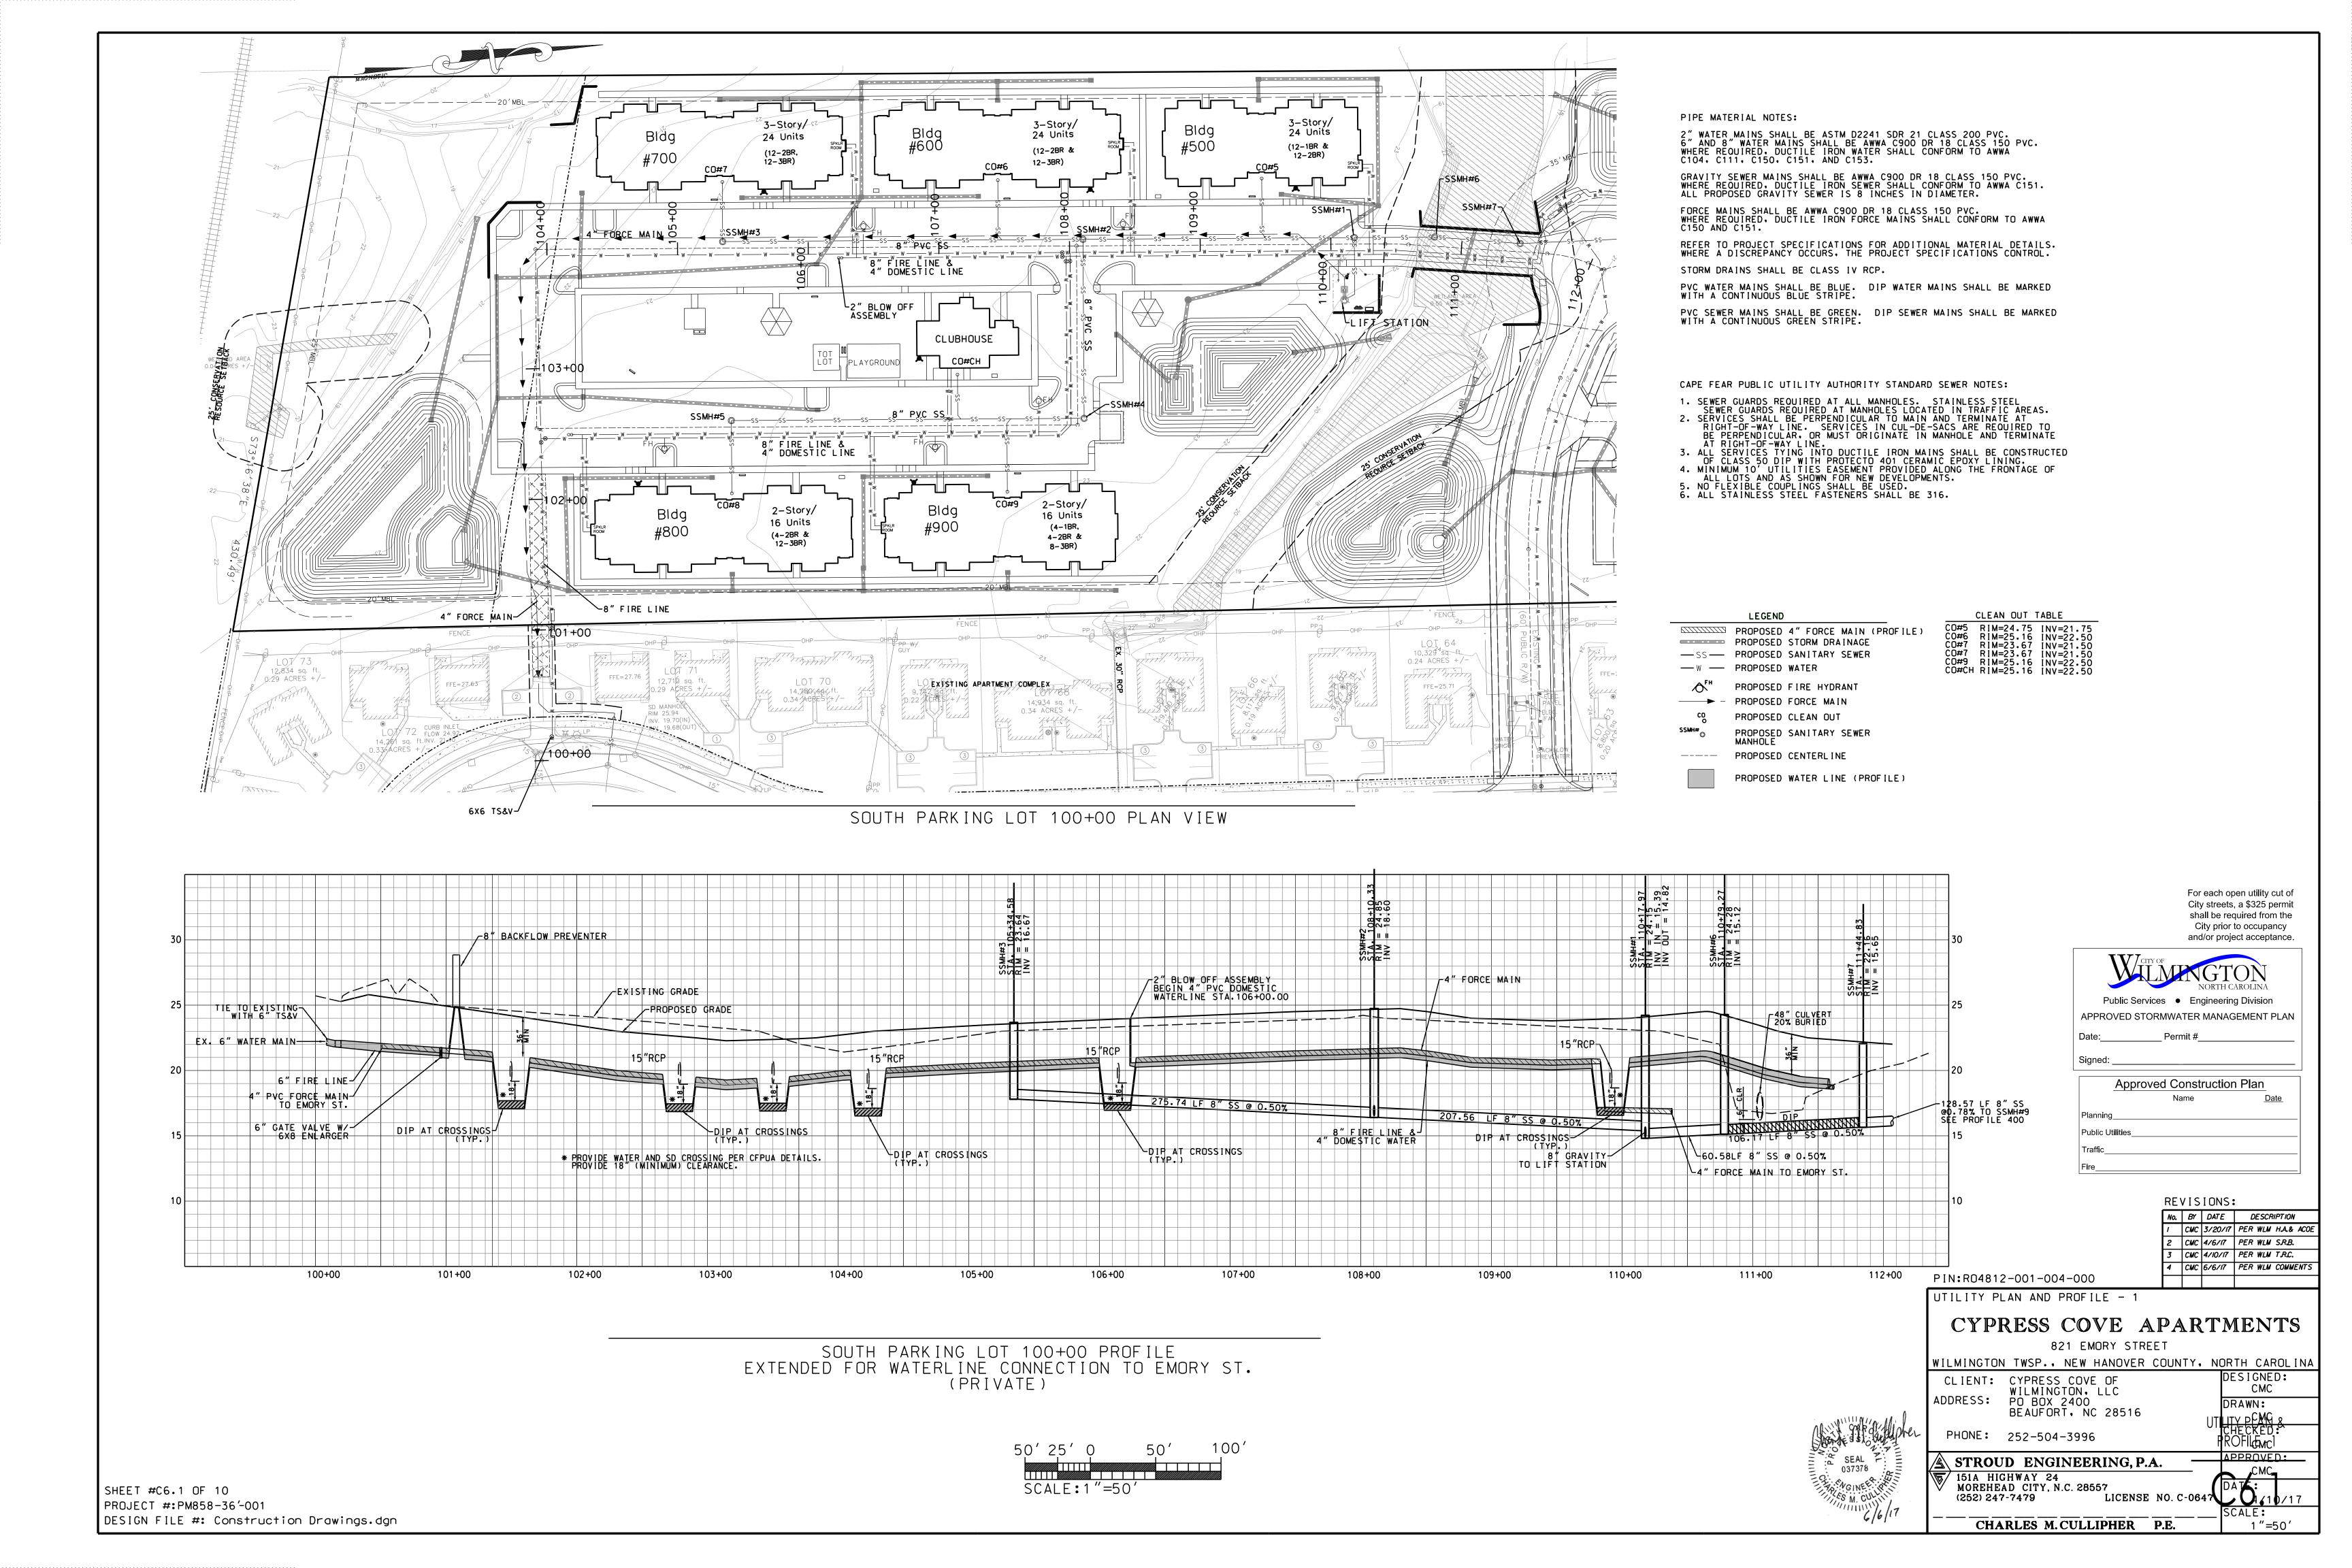

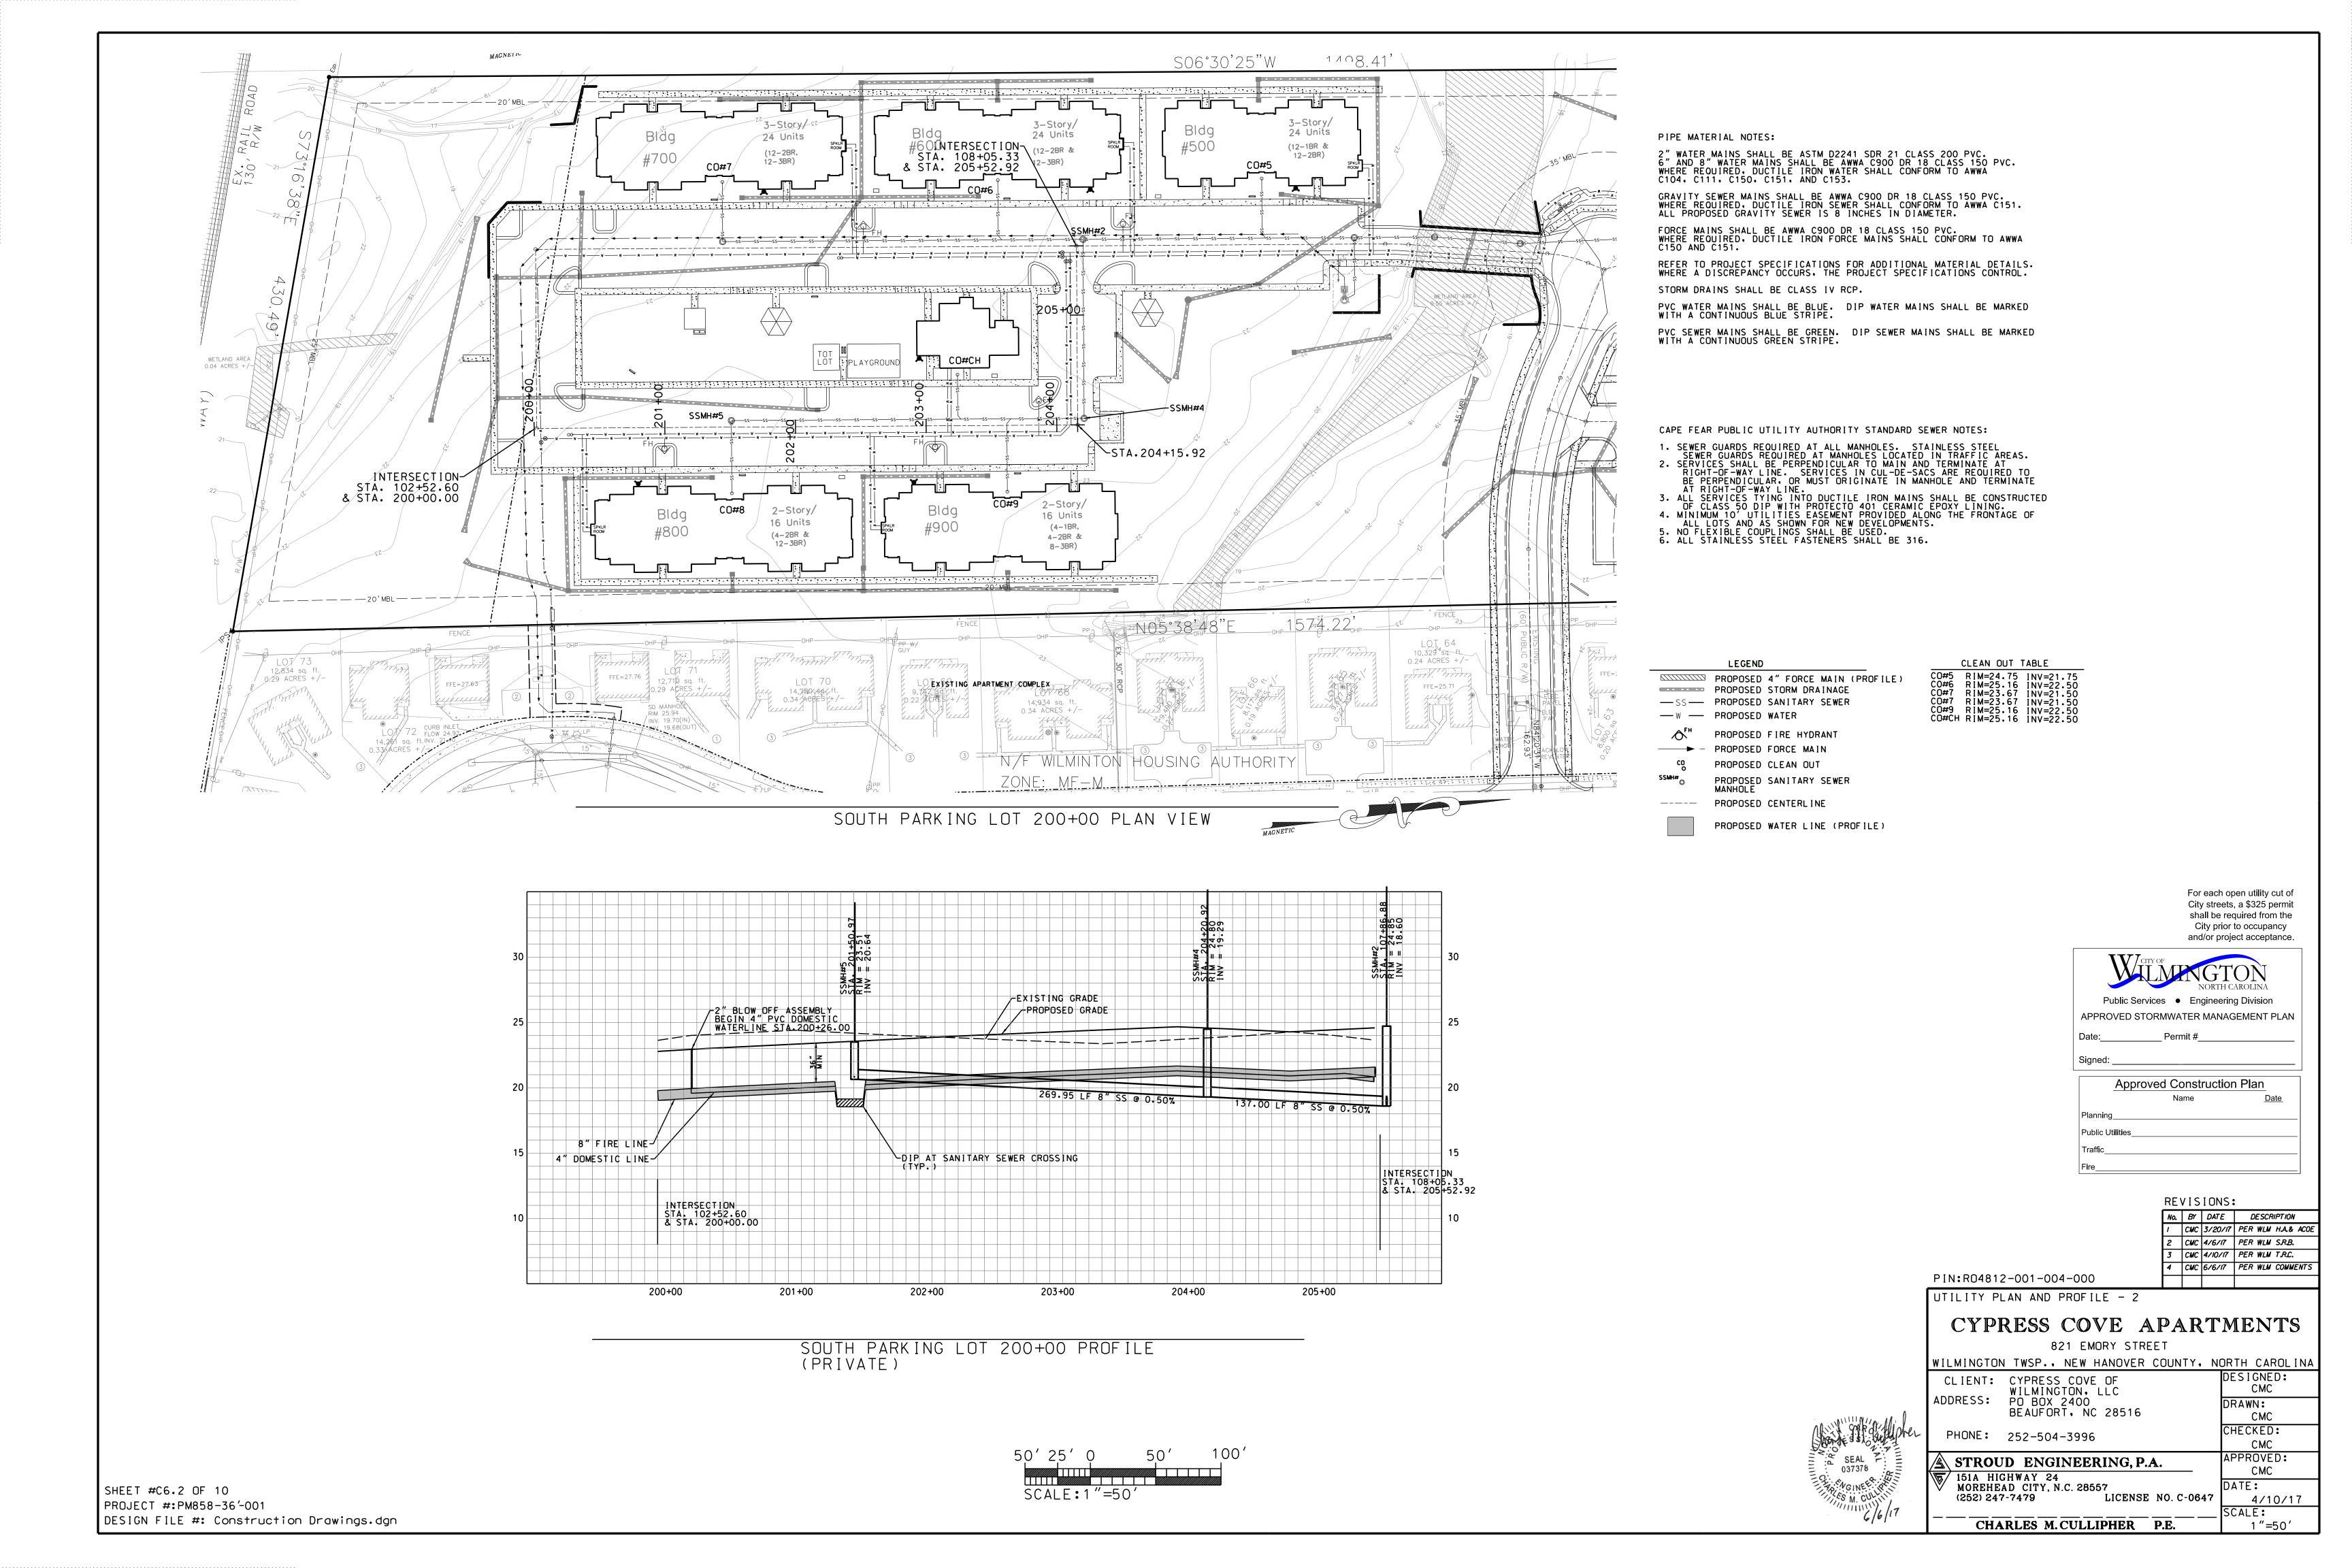

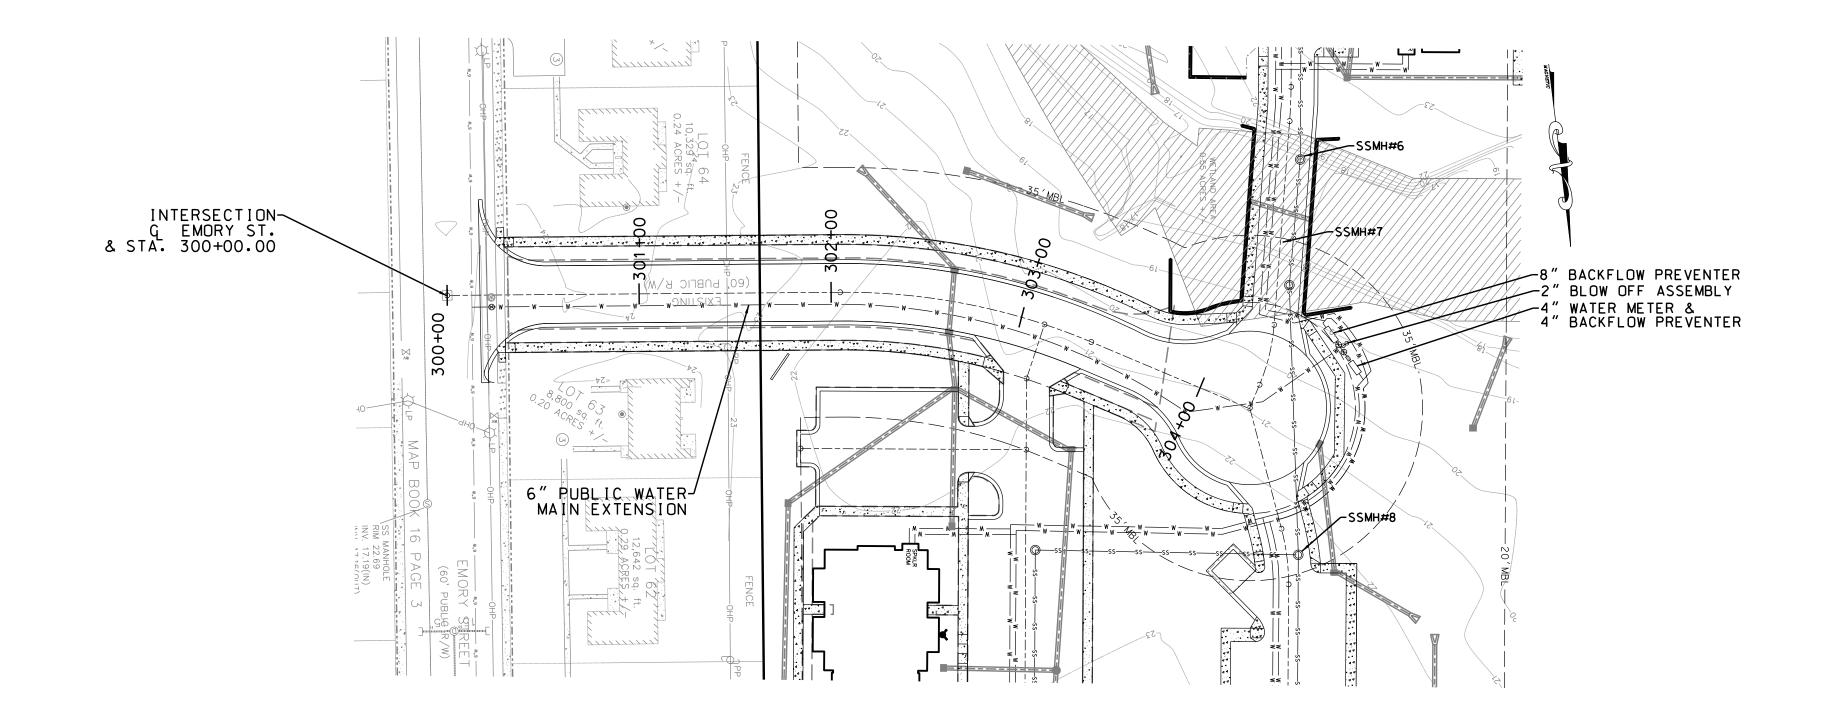

TURNER STREET PLAN VIEW 60' PUBLIC RIGHT-OF-WAY

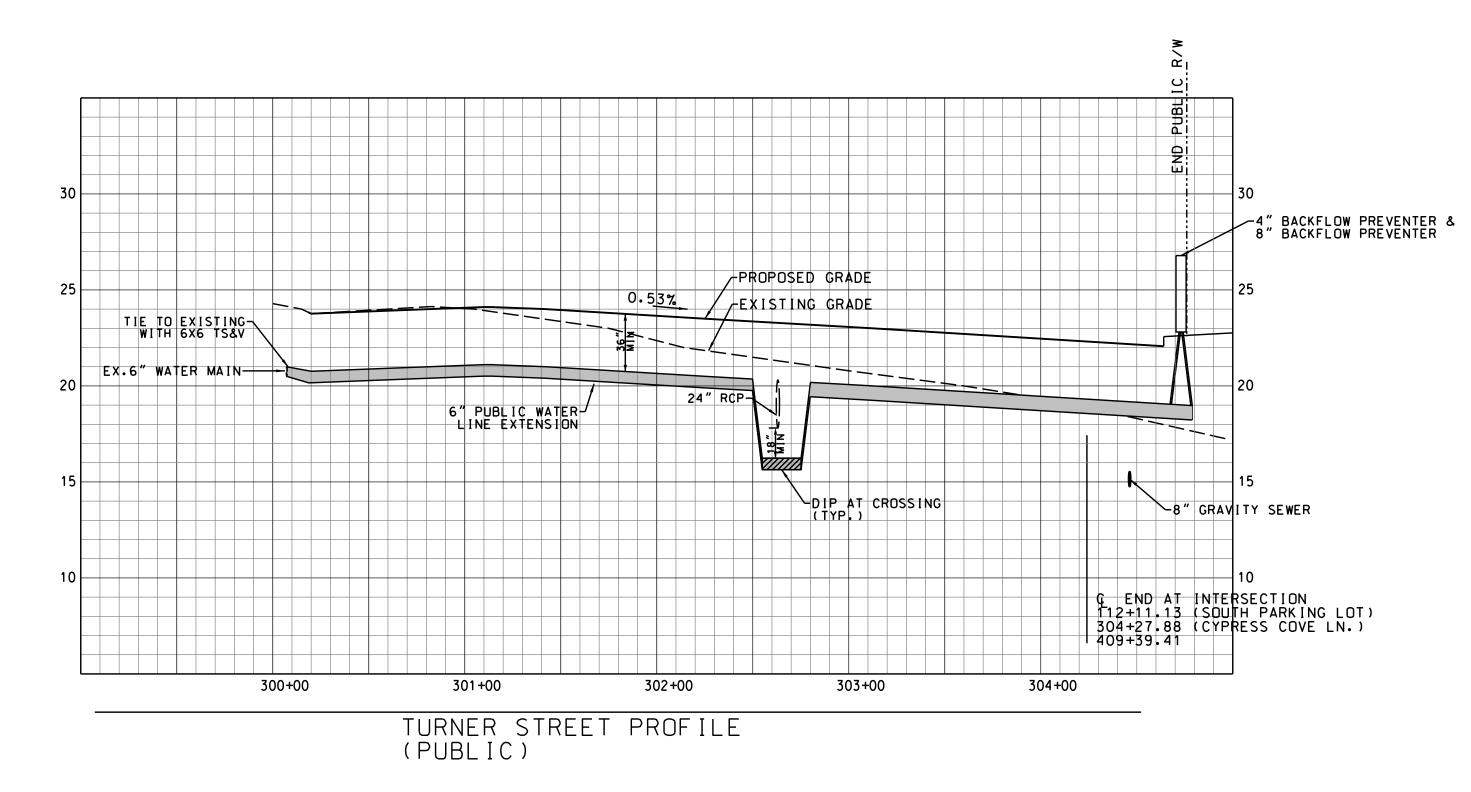

PIPE MATERIAL NOTES:

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	LEGEND	
	PROPOSED	4" FORCE MAIN (PROFILE)
		STORM DRAINAGE
—ss—	PROPOSED	SANITARY SEWER
— w —	PROPOSED	WATER
∕ FH	PROPOSED	FIRE HYDRANT
 -	PROPOSED	FORCE MAIN
co	PROPOSED	CLEAN OUT
SSMH#	PROPOSED MANHOLE	SANITARY SEWER
	PROPOSED	CENTERL INE
	PROPOSED	WATER LINE (PROFILE)

SEAL 037378

For each open utility cut of City streets, a \$325 permit shall be required from the City prior to occupancy



No.	BY	DATE	DESCR	IPTION
1	CMC	3/20/17	PER WLM	H.A.& ACOL
2	CMC	4/6/17	PER WLM	S.R.B.
3	CMC	4/10/17	PER WLM	T.R.C.
4	CMC	6/6/17	PER WLM	COMMENTS

PIN:R04812-001-004-000

UTILITY PLAN AND PROFILE - 3

CYPRESS COVE APARTMENTS

821 EMORY STREET WILMINGTON TWSP., NEW HANOVER COUNTY, NORTH CAROLINA

CLIENT: CYPRESS COVE OF WILMINGTON, LLC PO BOX 2400 BEAUFORT, NC 28516 DESIGNED: CMC DRAWN:

MOREHEAD CITY, N.C. 28557

(252) 247-7479

PHONE: 252-504-3996

STROUD ENGINEERING, P.A. 151A HIGHWAY 24

CMC DATE: LICENSE NO. C-0647 4/10/17 SCALE: CHARLES M. CULLIPHER P.E.

CMC CHECKED:


CMC

APPROVED:

1 "=50 '

100′ 50′ 25′ SCALE:1"=50

SHEET #C6.3 OF 10 PROJECT #:PM858-36'-001 DESIGN FILE #: Construction Drawings.dgn

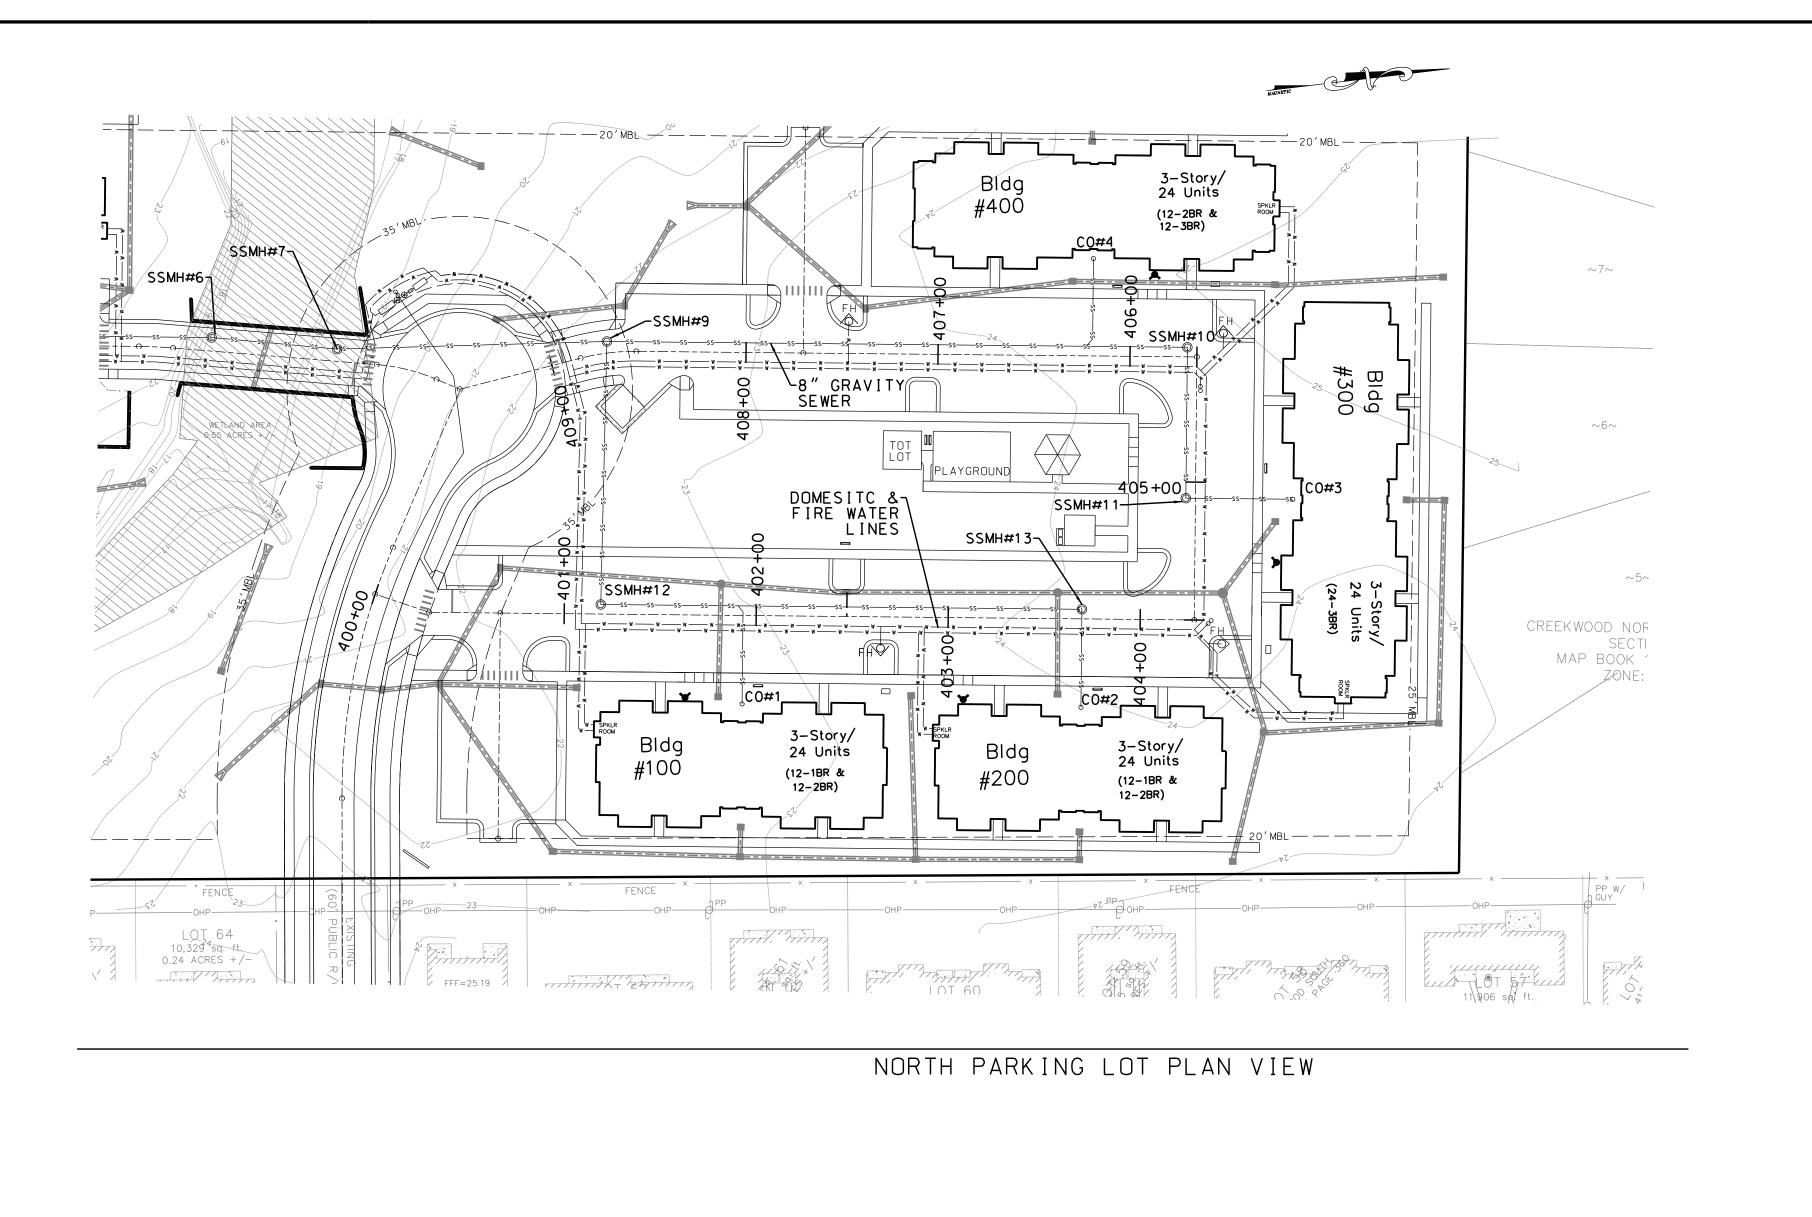

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GRAVITY SEWER MAINS SHALL BE AWWA C900 DR 18 CLASS 150 PVC. WHERE REQUIRED, DUCTILE IRON SEWER SHALL CONFORM TO AWWA C151. ALL PROPOSED GRAVITY SEWER IS 8 INCHES IN DIAMETER.

FORCE MAINS SHALL BE AWWA C900 DR 18 CLASS 150 PVC. WHERE REQUIRED. DUCTILE IRON FORCE MAINS SHALL CONFORM TO AWWA C150 AND C151.

REFER TO PROJECT SPECIFICATIONS FOR ADDITIONAL MATERIAL DETAILS. WHERE A DISCREPANCY OCCURS. THE PROJECT SPECIFICATIONS CONTROL. STORM DRAINS SHALL BE CLASS IV RCP.

PVC WATER MAINS SHALL BE BLUE. DIP WATER MAINS SHALL BE MARKED WITH A CONTINUOUS BLUE STRIPE. PVC SEWER MAINS SHALL BE GREEN. DIP SEWER MAINS SHALL BE MARKED WITH A CONTINUOUS GREEN STRIPE.

CAPE FEAR PUBLIC UTILITY AUTHORITY STANDARD SEWER NOTES:


- SEWER GUARDS REQUIRED AT ALL MANHOLES. STAINLESS STEEL
 SEWER GUARDS REQUIRED AT MANHOLES LOCATED IN TRAFFIC AREAS.
 SERVICES SHALL BE PERPENDICULAR TO MAIN AND TERMINATE AT
 RIGHT-OF-WAY LINE. SERVICES IN CUL-DE-SACS ARE REQUIRED TO
 BE PERPENDICULAR. OR MUST ORIGINATE IN MANHOLE AND TERMINATE
 AT RIGHT-OF-WAY LINE.
 ALL SERVICES TYING INTO DUCTILE IRON MAINS SHALL BE CONSTRUCTED
 OF CLASS 50 DIP WITH PROTECTO 401 CERAMIC EPOXY LINING.
 MINIMUM 10' UTILITIES EASEMENT PROVIDED ALONG THE FRONTAGE OF
 ALL LOTS AND AS SHOWN FOR NEW DEVELOPMENTS.
 NO FLEXIBLE COUPLINGS SHALL BE USED.
 ALL STAINLESS STEEL FASTENERS SHALL BE 316.

CLEAN OUT TABLE LEGEND CO#1 RIM=24.50 INV=21.83 CO#2 RIM=24.21 INV=22.54 CO#3 RIM=25.17 INV=22.50 CO#4 RIM=24.33 INV=21.66 PROPOSED 4" FORCE MAIN (PROFILE) PROPOSED STORM DRAINAGE — PROPOSED SANITARY SEWER — PROPOSED WATER PROPOSED FIRE HYDRANT PROPOSED FORCE MAIN PROPOSED CLEAN OUT PROPOSED SANITARY SEWER MANHOLE PROPOSED CENTERLINE PROPOSED WATER LINE (PROFILE)

60' PUBLIC R/W CYPRESS COVE DR. SSMH#10 STA. 405+70. RIM = 23.92 INV = 20.19 15" RCP _______ 249.87 LF 8" SS @ 0.50% -DIP AT CROSSING -78.59LF 8" SS -DIP AT CROSSING 34.66LF 8" SS-/ @1.76% -DIP AT CROSSING BEGIN 400+00 AT INTERSECTION STA, 303+12.48 CYPRESS COVE LN. 131.85 LF 8" PVC @ 0.53% ACROSS OPEN AREA TO \$SMH#8 128.57 LF 8" SS-@0.78% TO SSMH#7 SEE PROFILE 100 END AT INTERSECTION 112+11.13 (SOUTH PARKING LOT) 304+27.88 (CYPRESS COVE LN.) 409+39.41 DIP AT CROSSING 402+00 403+00 405+00 406+00 400+00 401+00 404+00 407+00 409+00 410+00

> NORTH PARKING LOT PROFILE (PRIVATE)

> > 100′ 50′25′ SCALE:1"=50

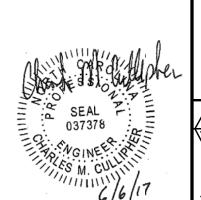

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Public Services • Engineering Division
APPROVED STORMWATER MANAGEMENT PLAN
Date:Permit #
Signed:
Approved Construction Plan
Name <u>Date</u>
Planning
Public Utilities
Traffic

RE	۷IS	I ONS:	}
No.	BY	DATE	DESCRIPTION
1	CMC	3/20/17	PER WLM H.A.& ACOE
2	CMC	4/6/17	PER WLW S.R.B.
3	CMC	4/10/17	PER WLM T.R.C.
4	CMC	6/6/17	PER WLM COMMENTS

PIN:R04812-001-004-000

UTILITY PLAN AND PROFILE - 4

CYPRESS COVE APARTMENTS

821 EMORY STREET WILMINGTON TWSP., NEW HANOVER COUNTY, NORTH CAROLINA

CLIENT: CYPRESS COVE OF WILMINGTON, LLC PO BOX 2400 BEAUFORT, NC 28516

PHONE: 252-504-3996

DRAWN: CMC IL CHEICAND D& ROFILECMC APPROVED: CMC


DESIGNED: CMC


STROUD ENGINEERING, P.A. 151A HIGHWAY 24 MOREHEAD CITY, N.C. 28557


CHARLES M. CULLIPHER P.E.


(252) 247-7479


SHEET #C6.4 OF 10 PROJECT #:PM858-36'-001 DESIGN FILE #: Construction Drawings.dgn

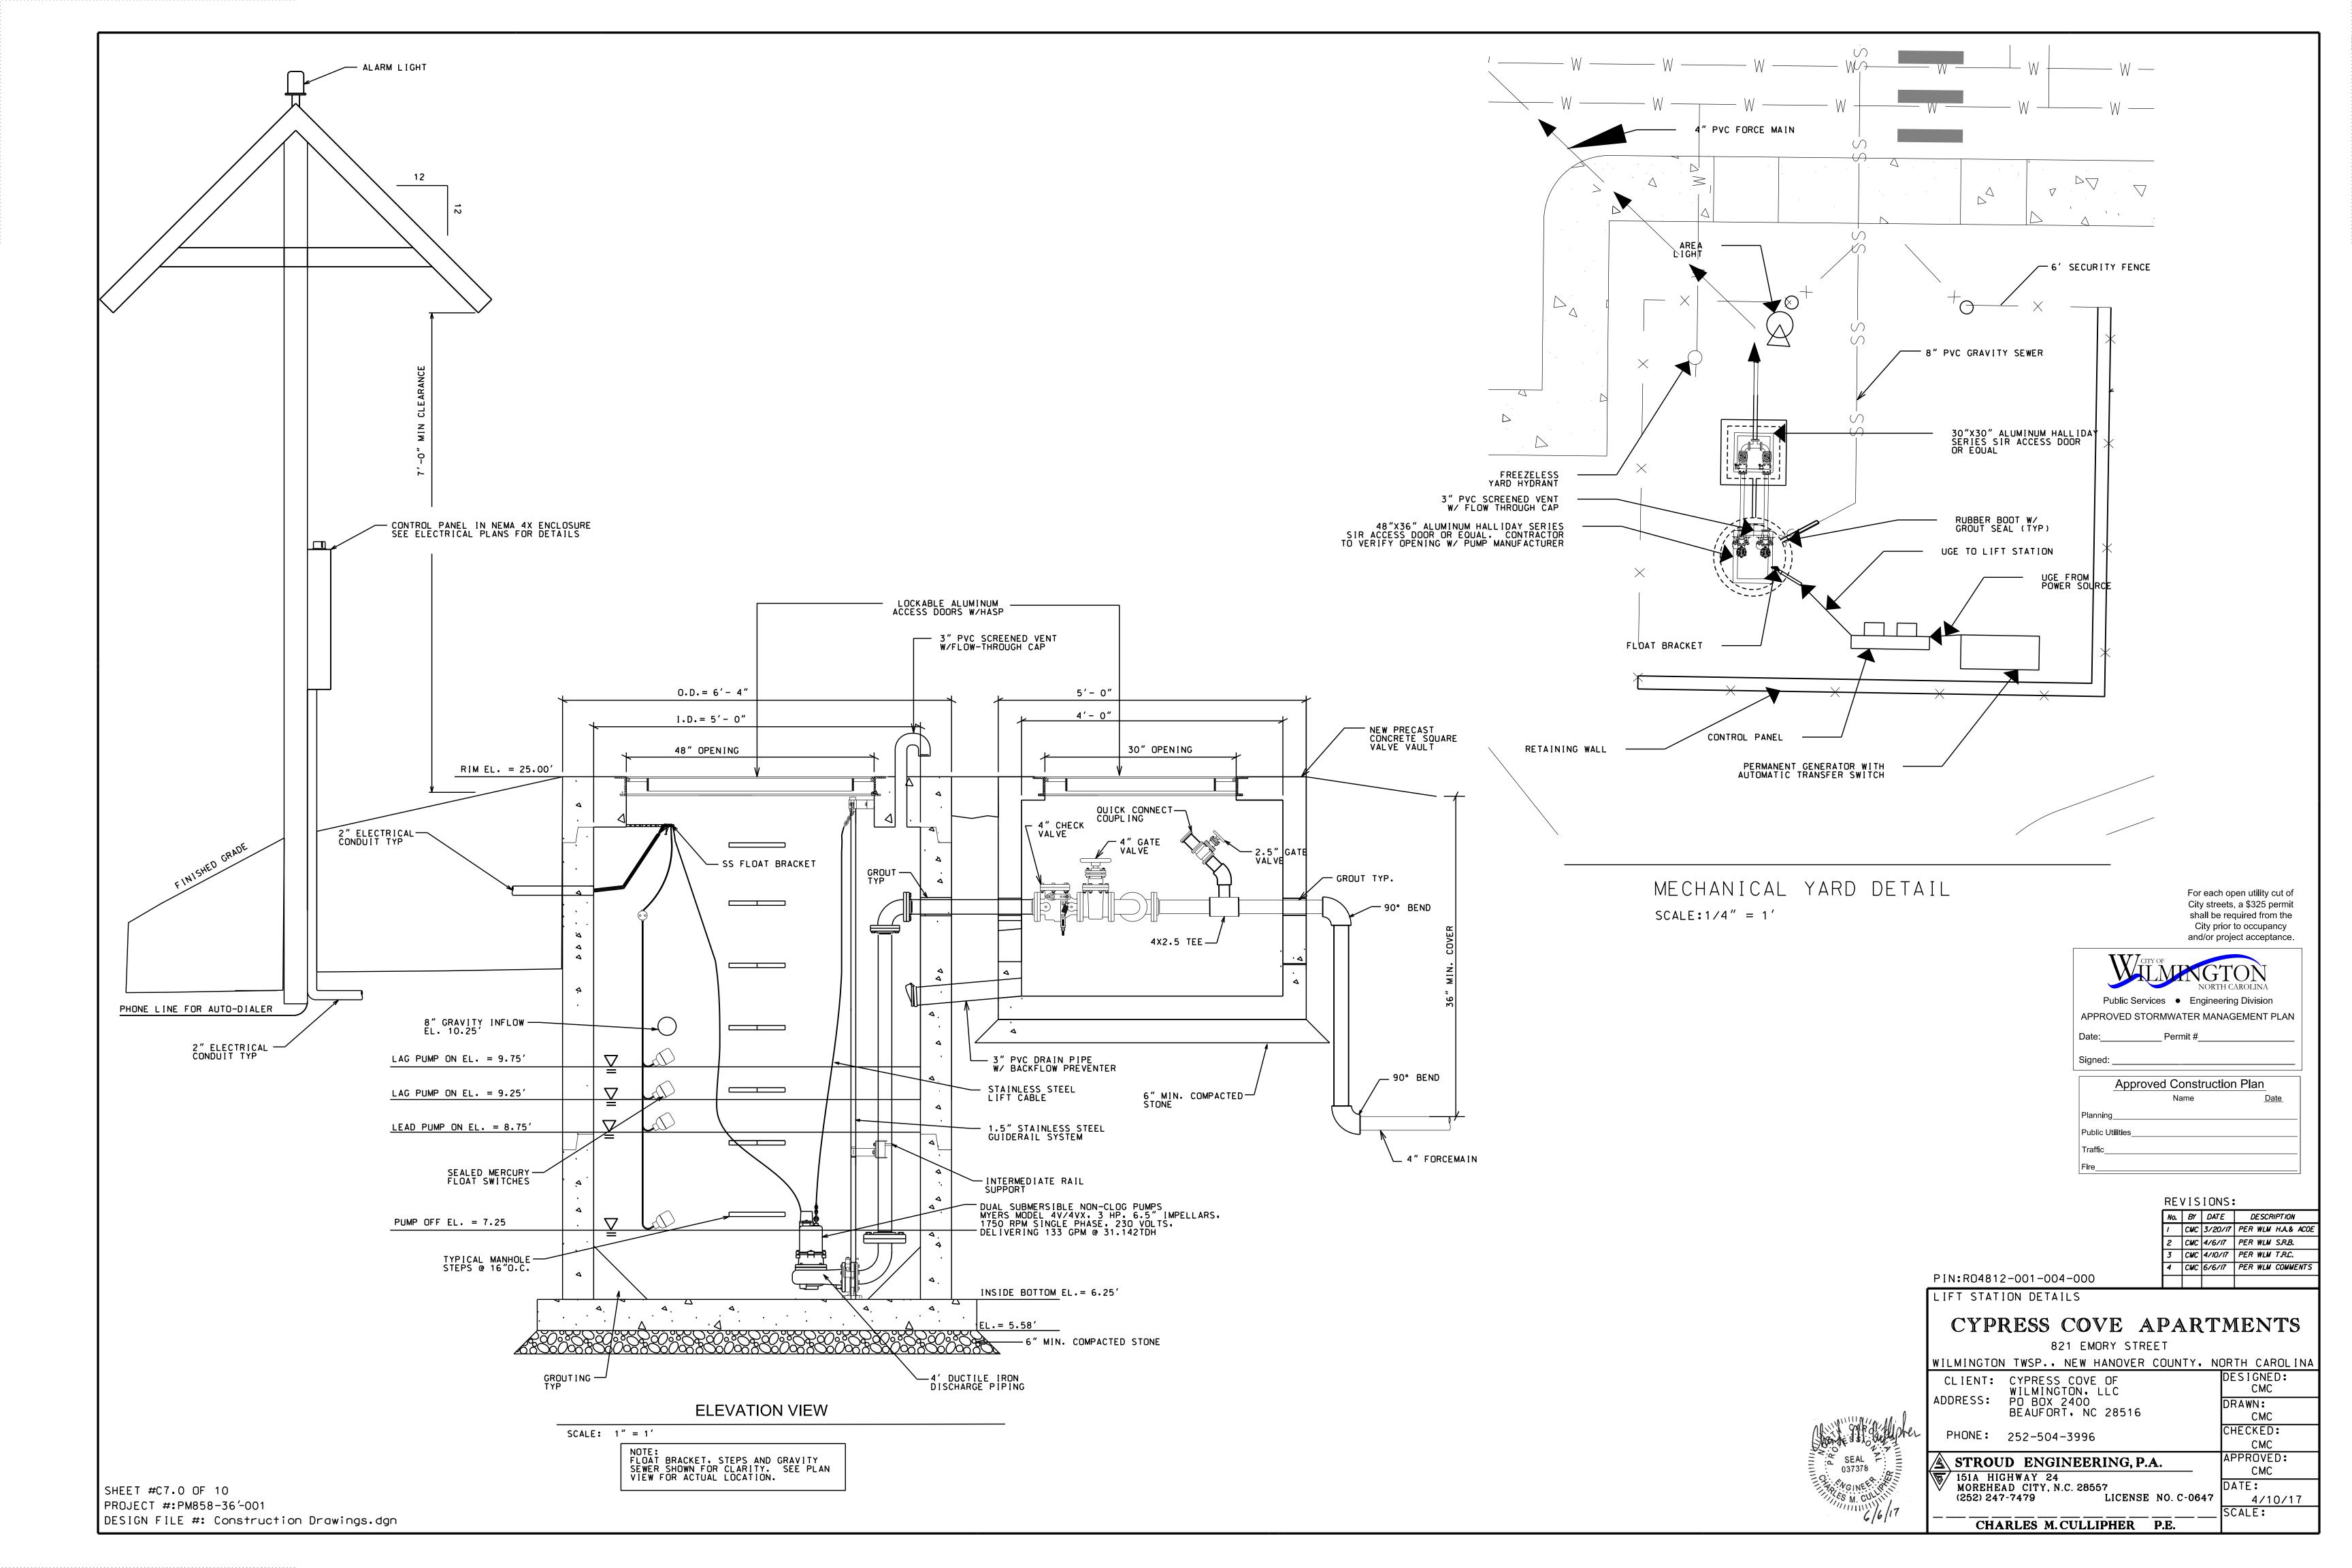


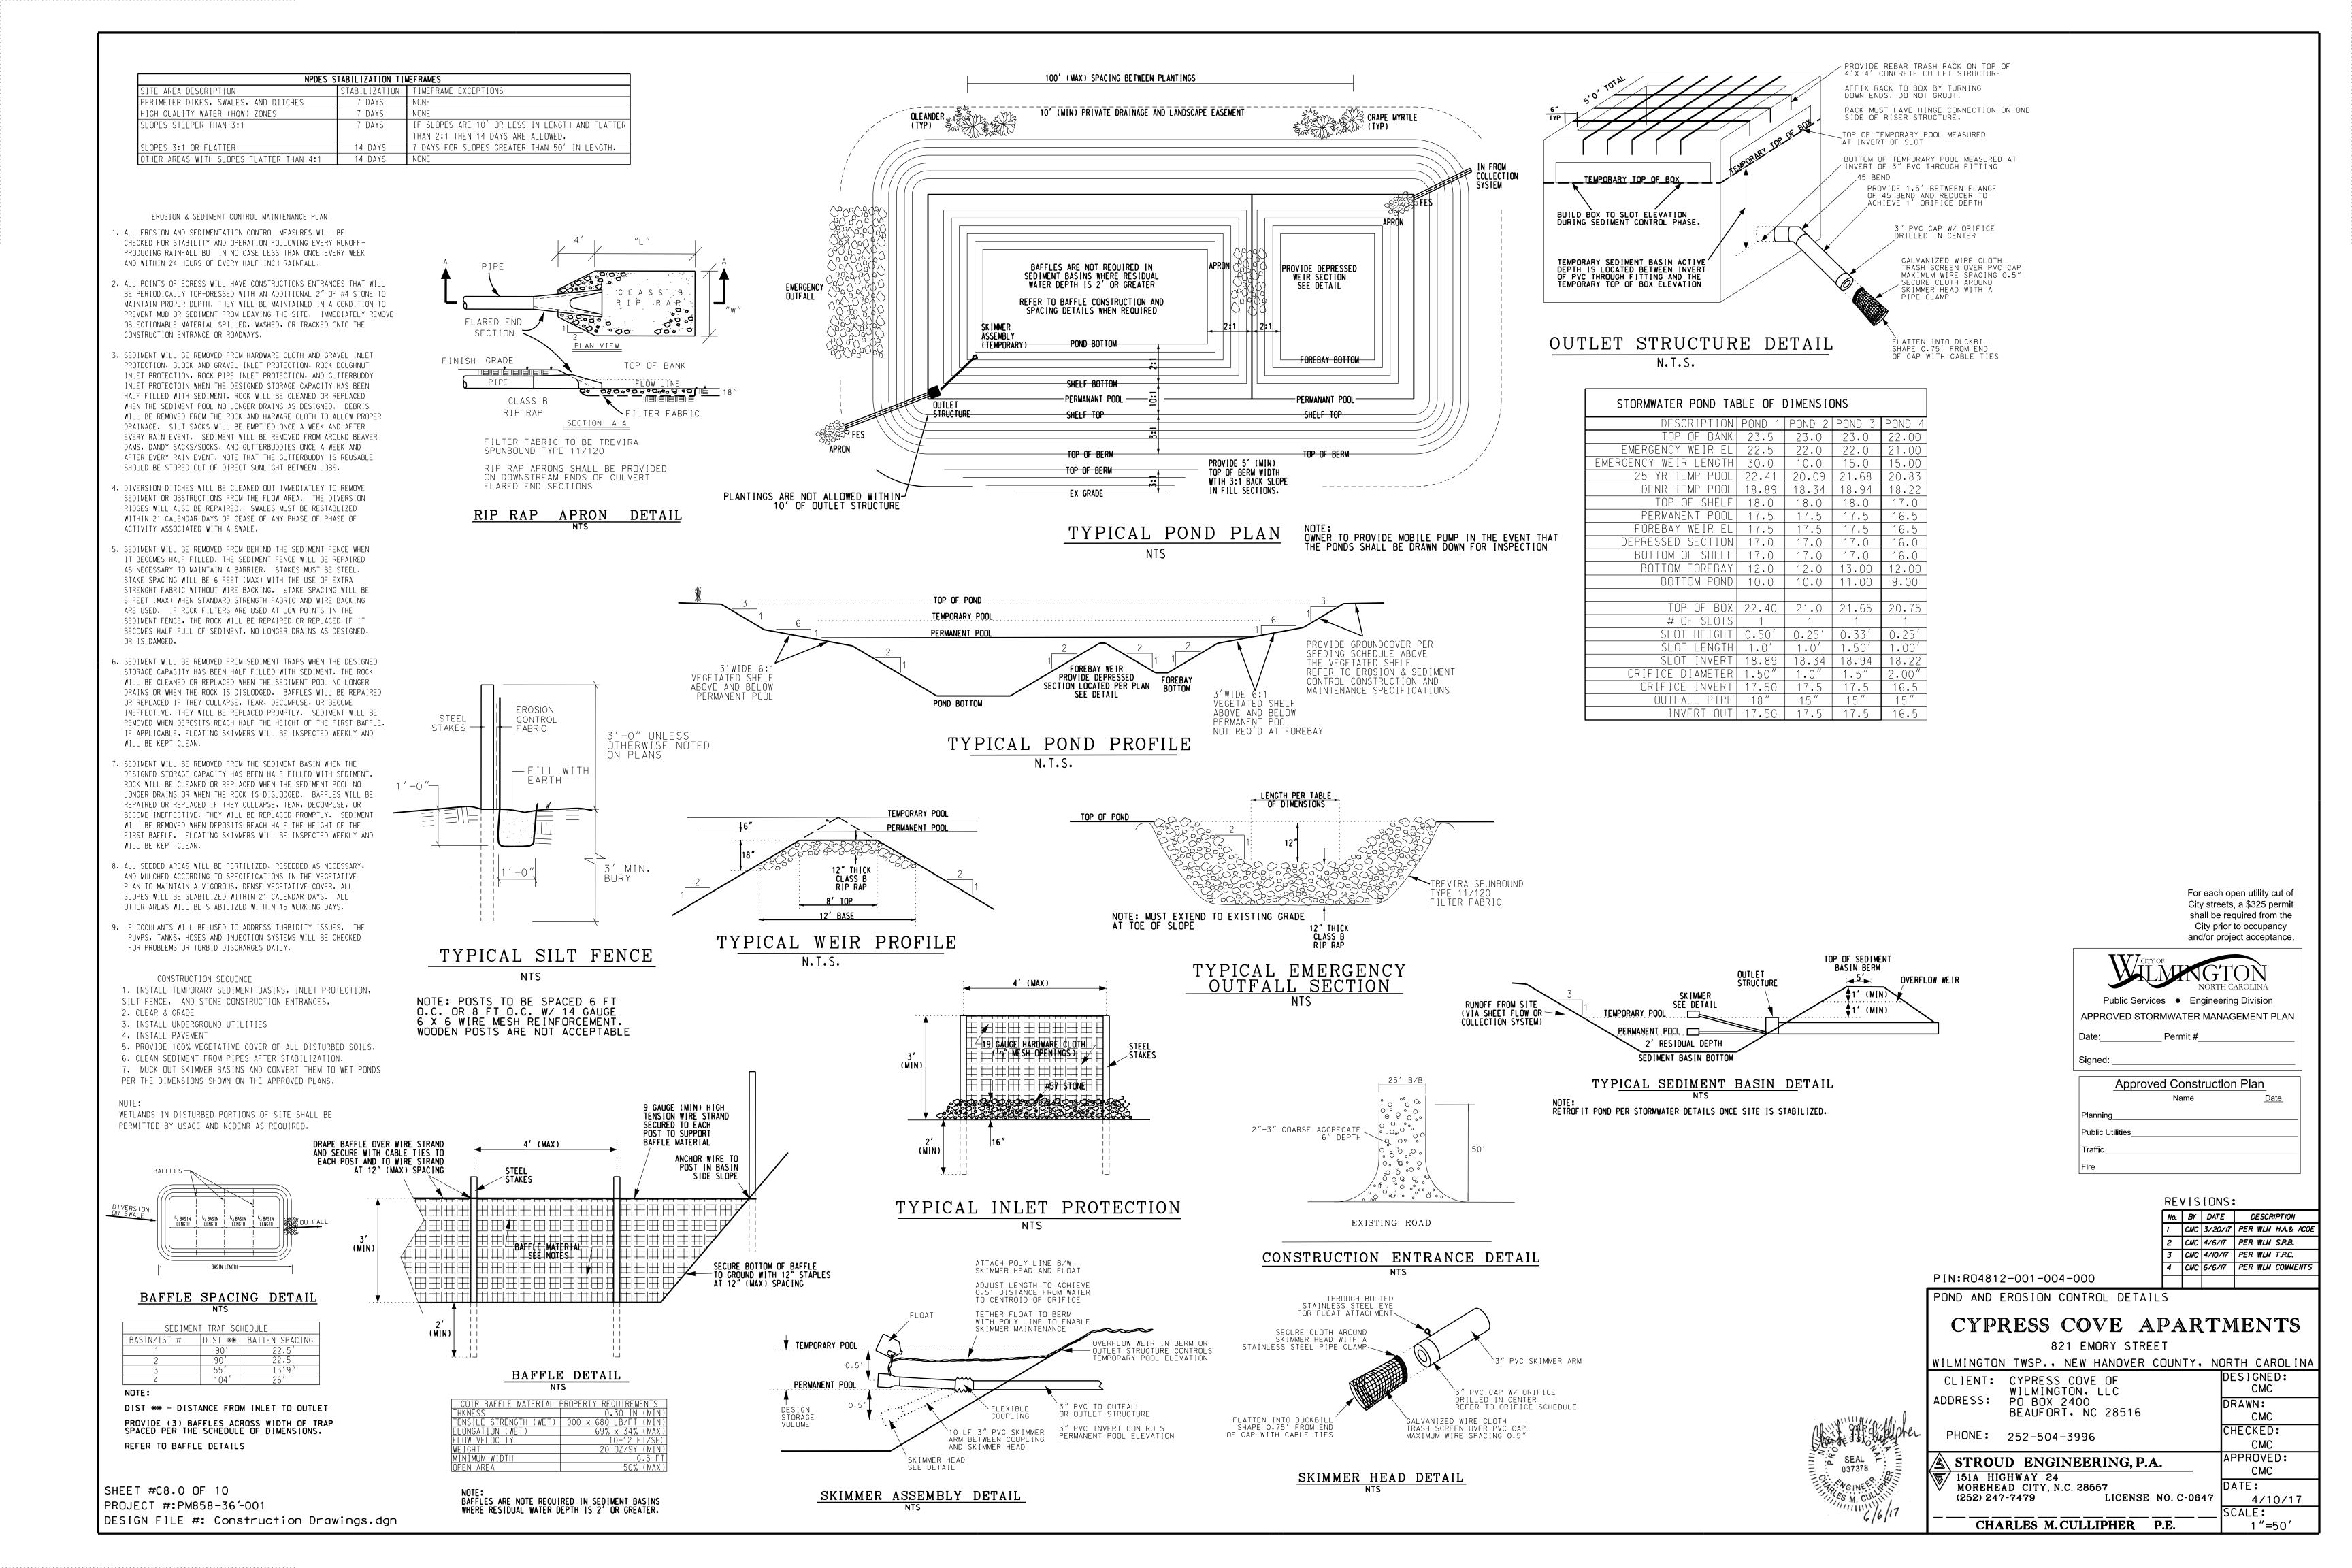


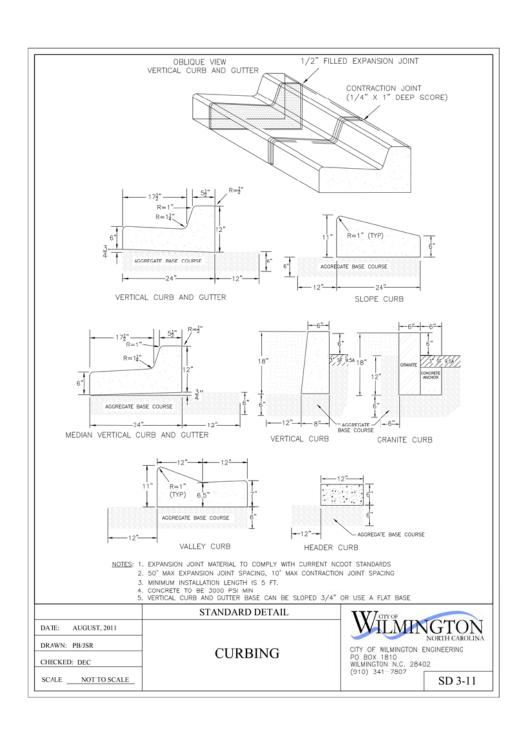


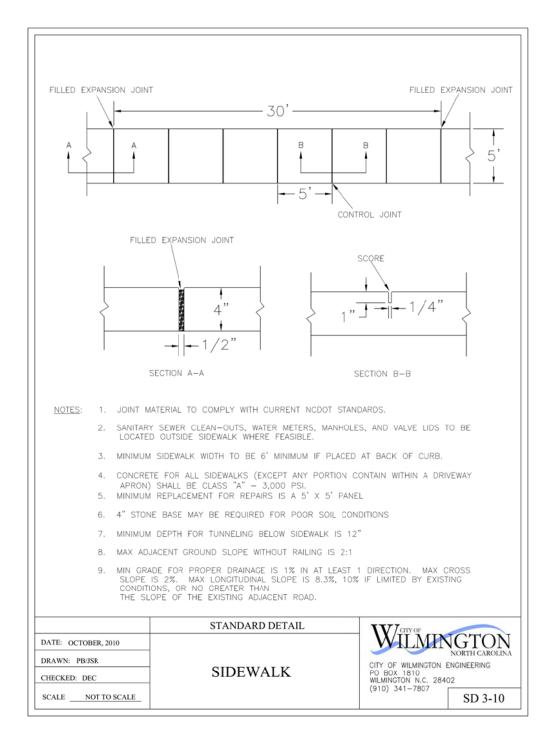


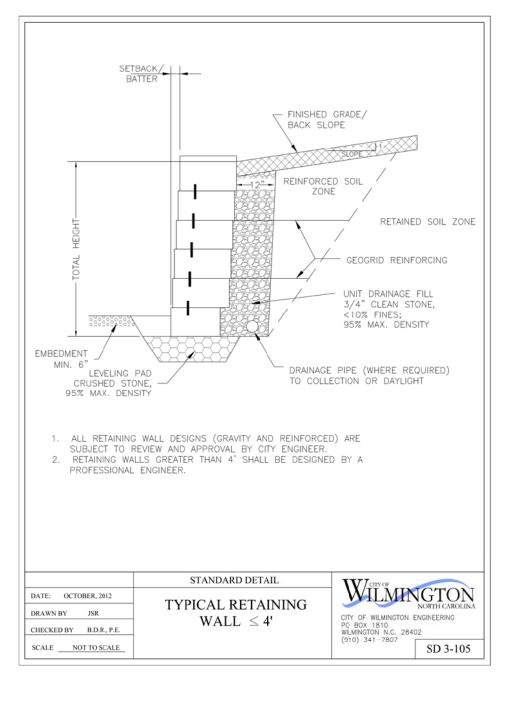


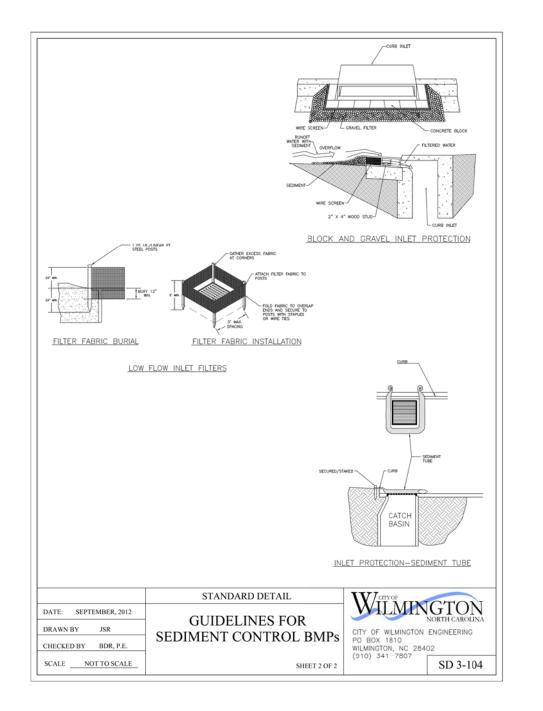


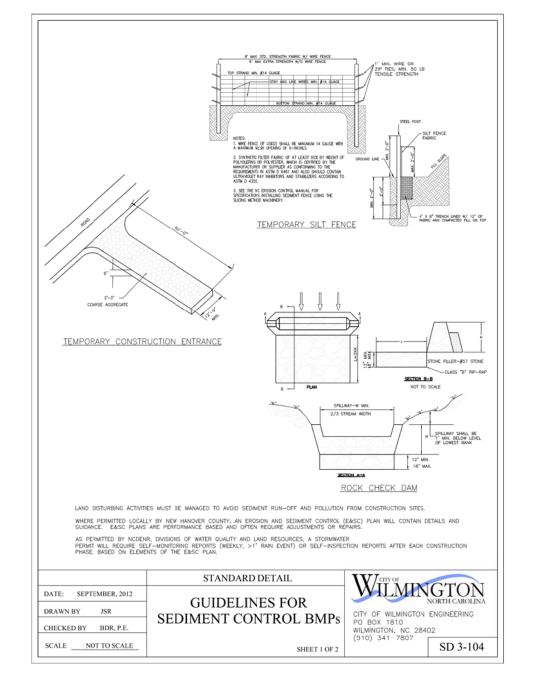


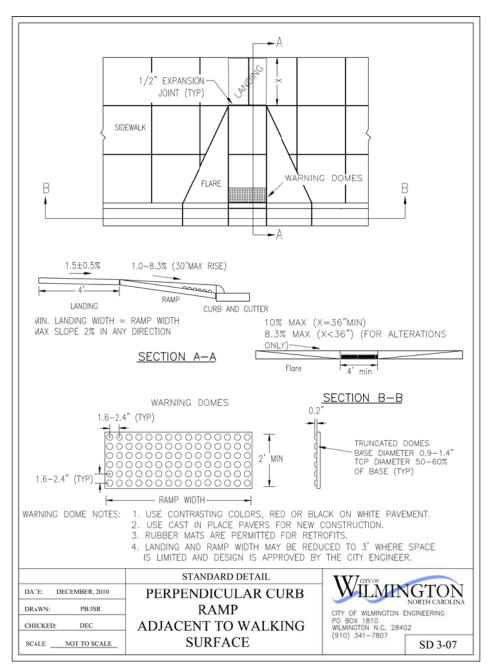


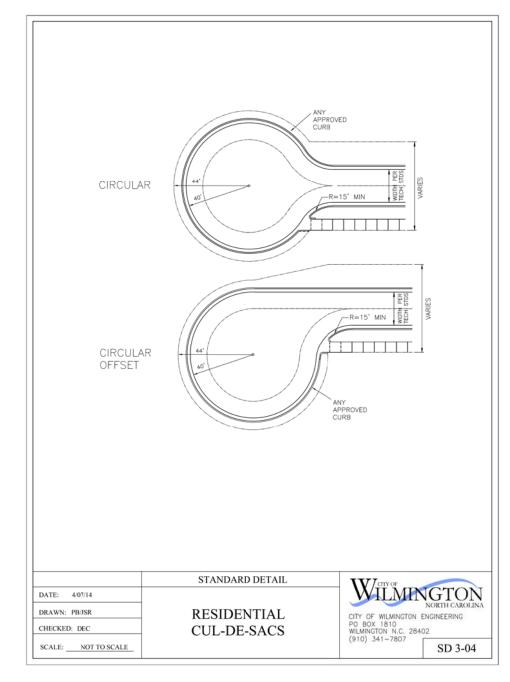


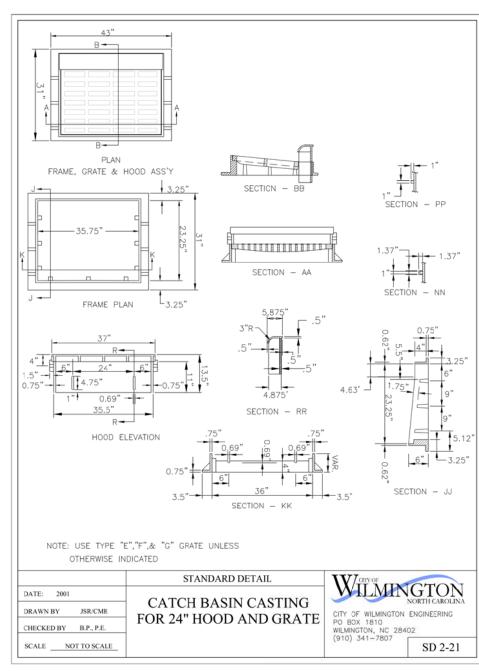


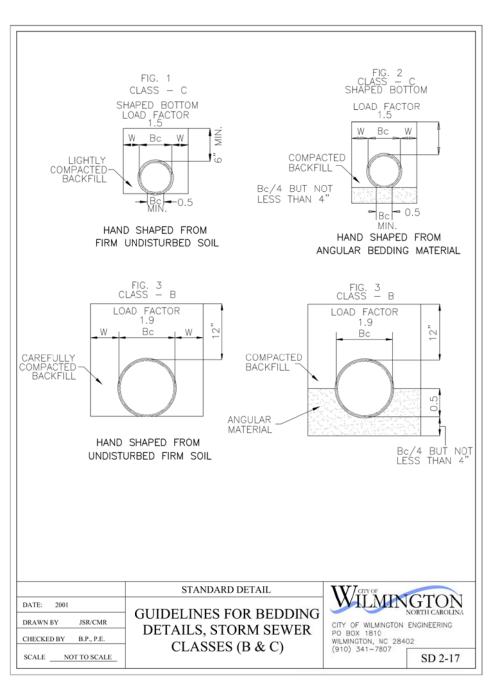

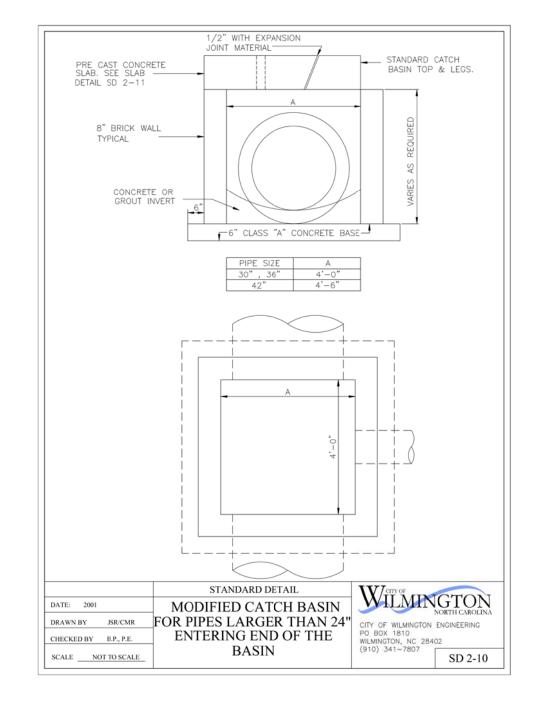

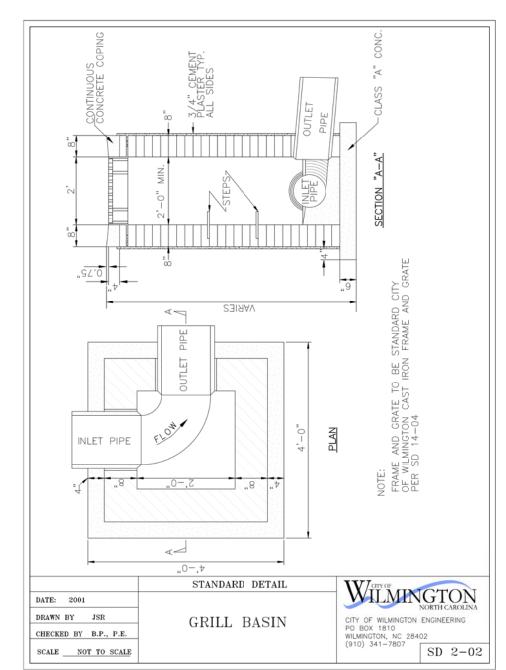

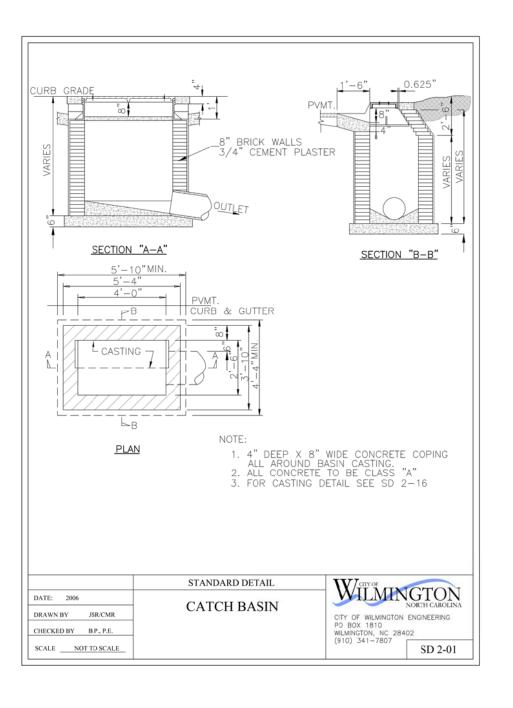

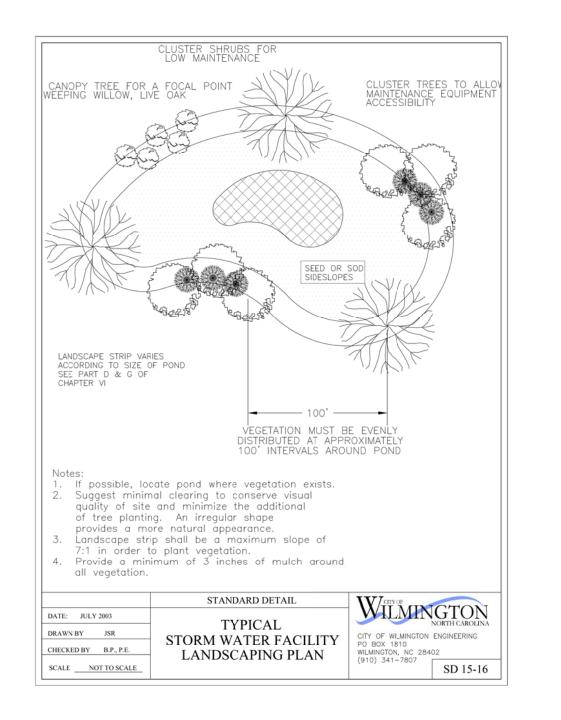

will be allowed only upon approval of the Traffic Engineer. 2. Wheel stops shall be required three (3) feet from the end of parking stall when using eighteen (18) feet deep stalls. 3. Curbing, crossties, utility poles, etc., can be used as wheel stops. (Must be anchored down) 4. All medians shall be a minimum of six (6) feet wide. 5. Parking bays which terminate at a circulation way shall provide for a minimum turning radius of twenty five (25) feet, as measured from the edge of the travel portion. 6. All parking stall markings and lane arrows shall be 7. All other pavement markings, signs or other traffic control devices shall conform to the latest edition and/or interpretation of the Manual on Uniform Traffic Control Devices (MUTCD). 8. No obstructions will be allowed adjacent to a parking stall which would prevent safe ingress and egress from a parked vehicle. 9. Parking in fire lanes and in non-residential driveways

Variances on stall widths, angle and other dimensions

shall be prevented by standard signs and as needed by STANDARD DETAIL WILMINGTON PARKING FACILITY CITY OF WILMINGTON ENGINEERING PO BOX 1810 WILMINGTON, NC 28402 (910) 341-7807 DRAWN BY JSR/CMR DESIGN NOTES CHECKED BY B.P., P.E. SCALE NOT TO SCALE

City streets, a \$325 permit shall be required from the City prior to occupancy and/or project acceptance.

For each open utility cut of

Public Services Engineering Division
APPROVED STORMWATER MANAGEMENT PLAN
Date: Permit #
Signed:
Approved Construction Plan
Name <u>Date</u>
Planning
Public Utilities
Traffic
Fire

REVISIONS:							
	No.	BY	DATE	DESCRIPTION			
	1	CMC	3/20/17	PER WLM H.A.& ACOE			
	2	CMC	4/6/17	PER WLM S.R.B.			
	3	CMC	4/10/17	PER WLM T.R.C.			
	4	CMC	6/6/17	PER WLM COMMENTS			

DRAWN:

DATE:

SCALE:

CMC

CMC

APPROVED:

CMC

4/10/17

1"=50'

CHECKED:

PIN:R04812-001-004-000

SITE DETAILS

SEAL

037378

- PON OINEE

CYPRESS COVE APARTMENTS 821 EMORY STREET


WILMINGTON TWSP., NEW HANOVER COUNTY, NORTH CAROLINA DESIGNED: CMC


CLIENT: CYPRESS COVE OF WILMINGTON, LLC PO BOX 2400 BEAUFORT, NC 28516


PHONE: 252-504-3996

LICENSE NO. C-0647

STROUD ENGINEERING, P.A. MOREHEAD CITY, N.C. 28557 (252) 247-7479 CHARLES M. CULLIPHER P.E.

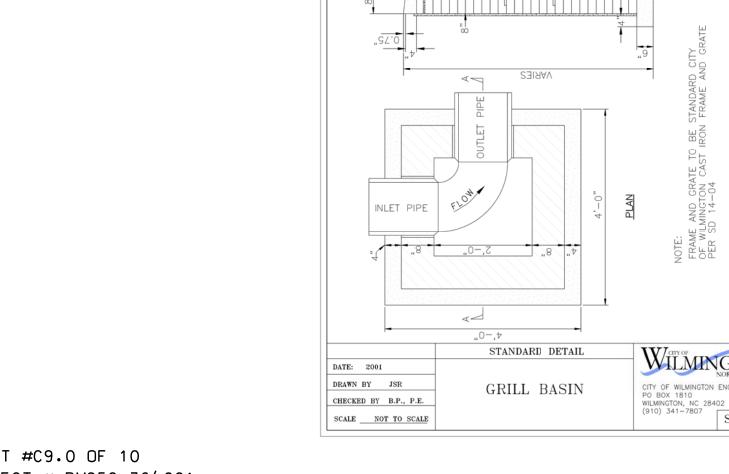

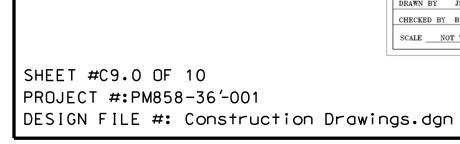

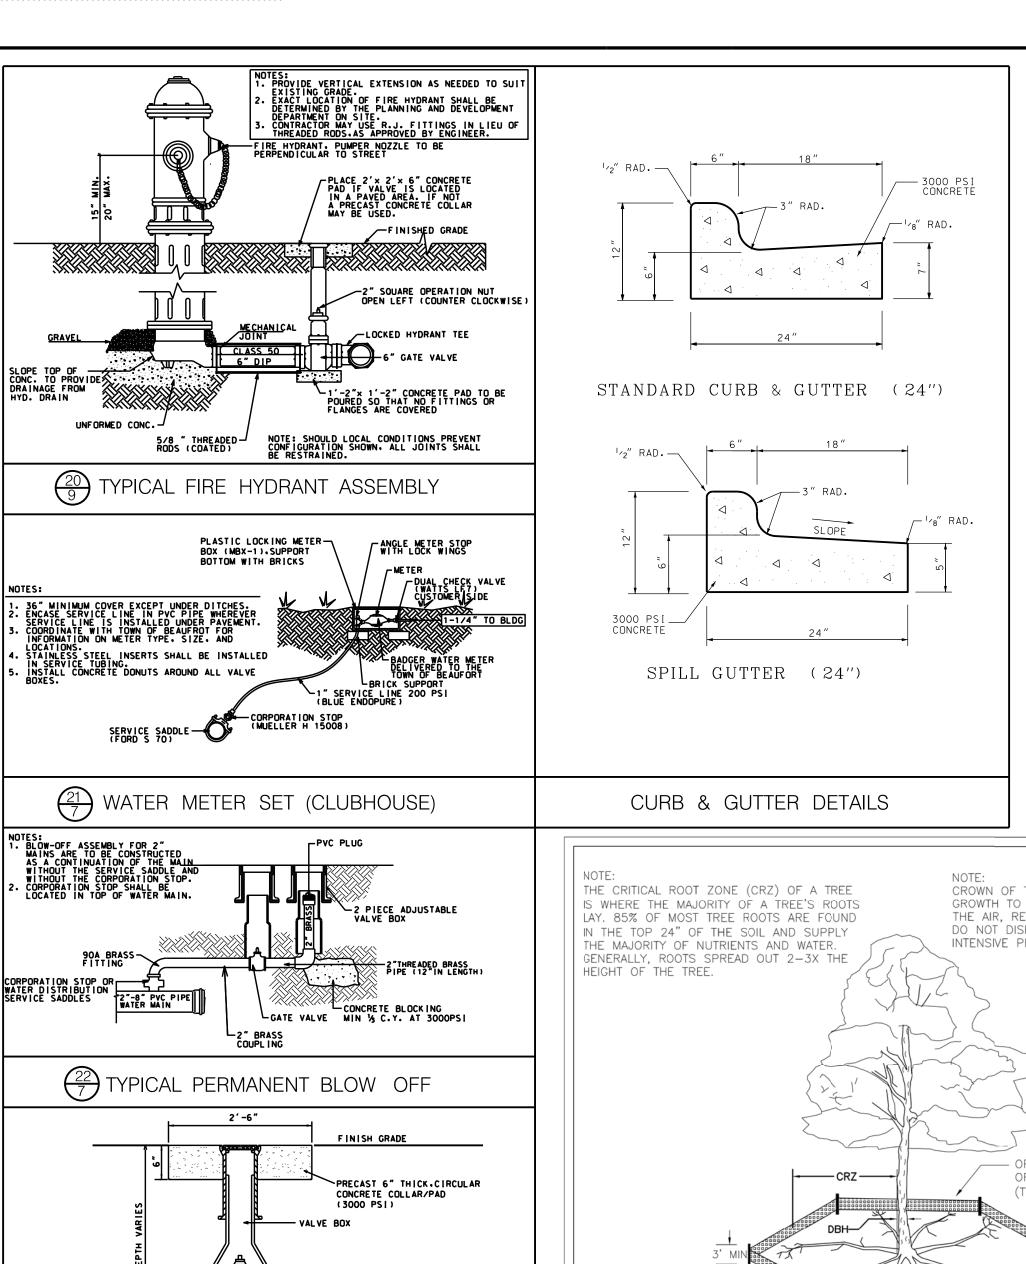

- NEW GATE VALVE

NEW GATE VALVE SEE PLAN FOR SIZE

DATE: JAN, 2015

DRAWN BY JSR

CHECKED BY RDG, P.E.


SCALE NOT TO SCALE


NEW GATE VALVE & VALVE BOX DETAIL


TAPPING SLEEVE - 1

BACKSIDE TAPPING OF EXISTING MAIN SHALL BE APPROVED BY THE ENGINEER PRIOR TO INSTALLATION OF TAP.


 $\frac{24}{7}$ TAPPING DETAIL

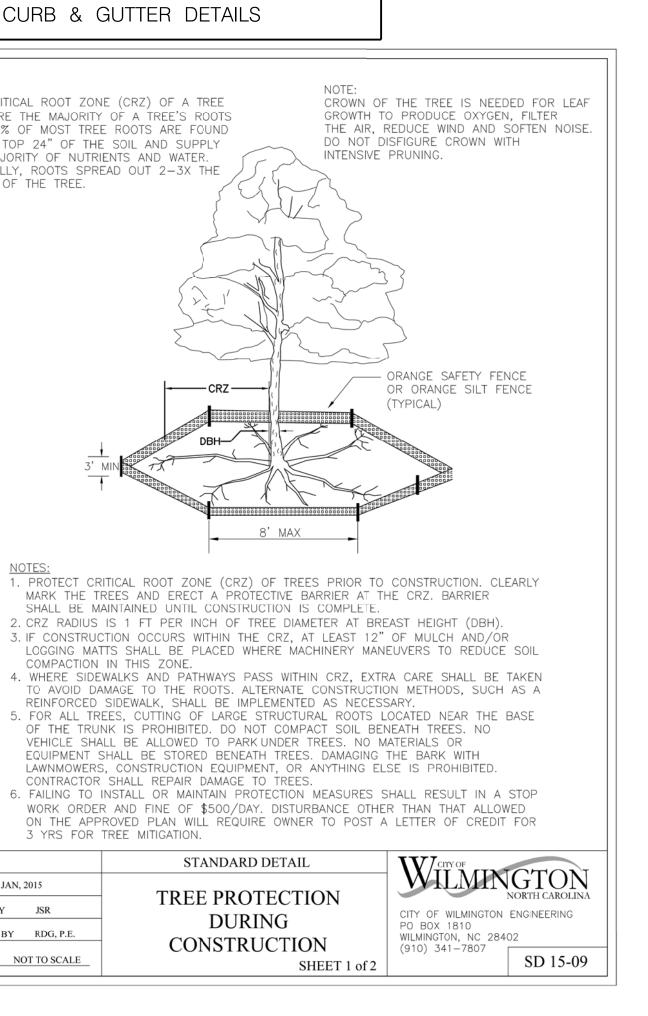


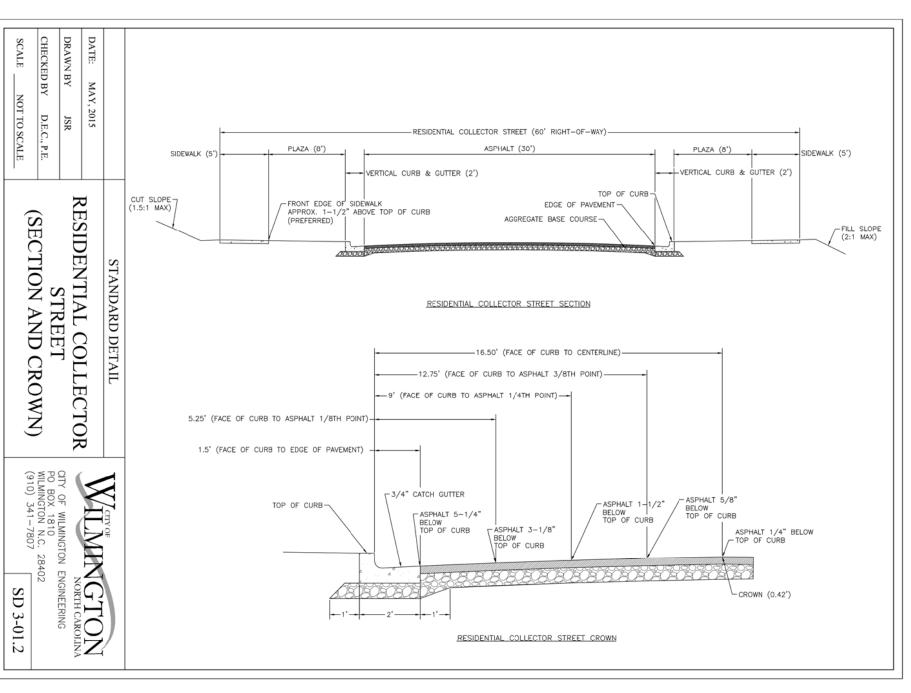


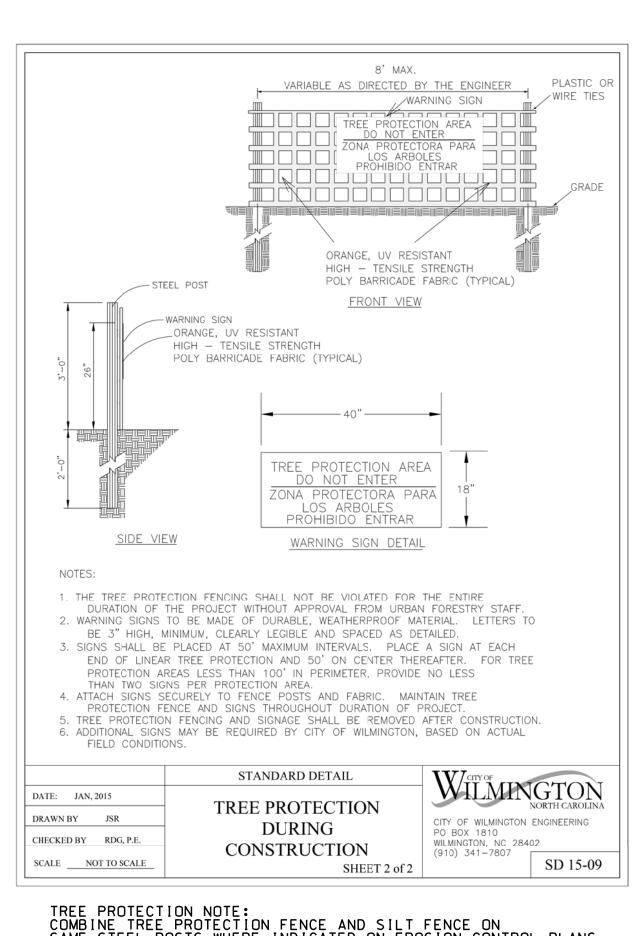


TREE PROTECTION NOTE:
COMBINE TREE PROTECTION FENCE AND SILT FENCE ON
SAME STEEL POSTS WHERE INDICATED ON EROSION CONTROL PLANS

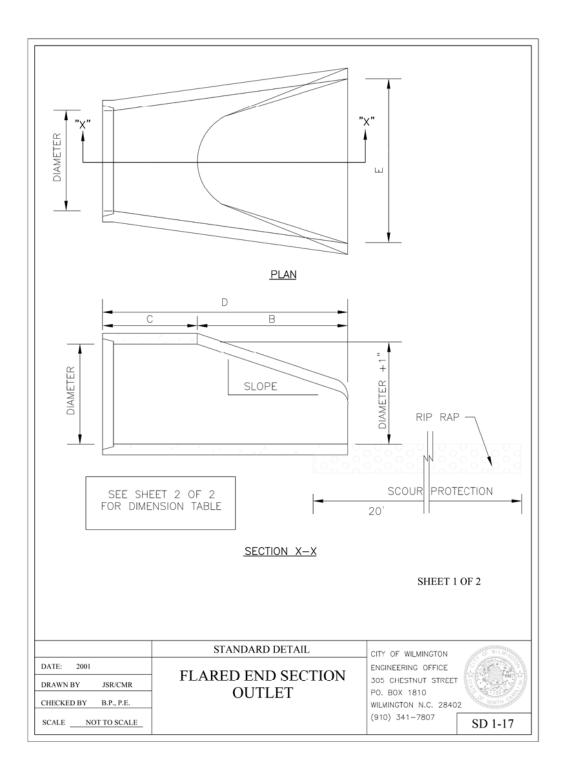

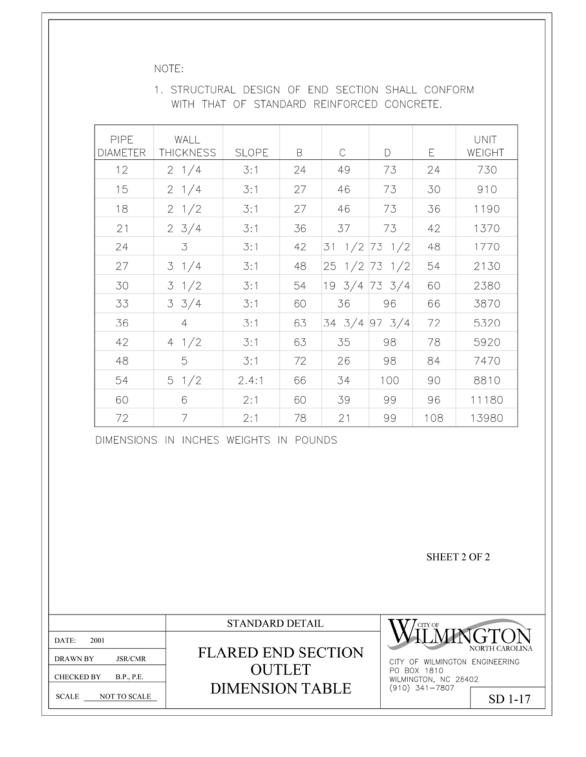

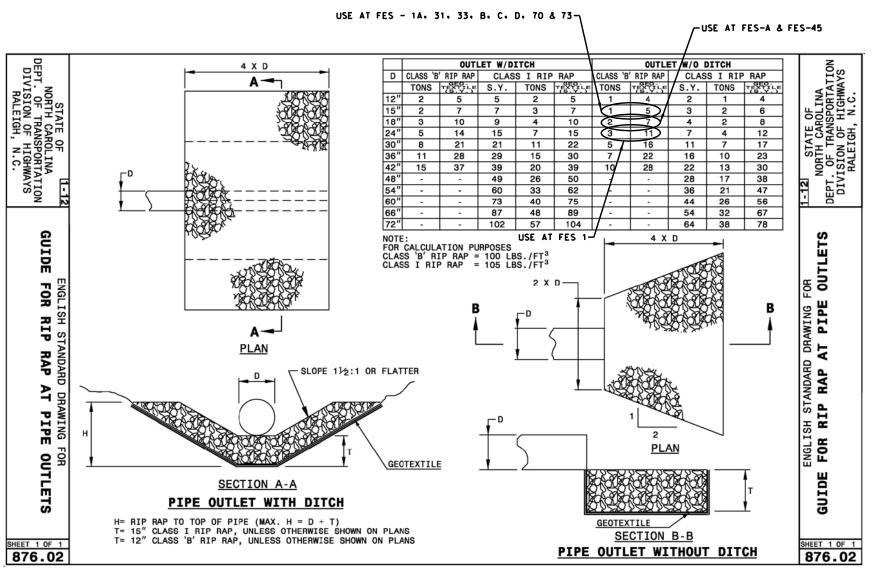

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Approved Construction Plan

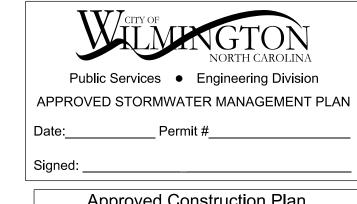REVISIONS:

No.	BY	DATE	DESCRIPTION
1	CMC	3/20/17	PER WLM H.A.& ACOE
2	CMC	4/6/17	PER WLM S.R.B.
3	CMC	4/10/17	PER WLM T.R.C.
4	CMC	6/6/17	PER WLM COMMENTS

PIN:R04812-001-004-000

SITE DETAILS

037378

SONGINEER.

CYPRESS COVE APARTMENTS

821 EMORY STREET

WILMINGTON TWSP., NEW HANOVER COUNTY, NORTH CAROLINA CLIENT: CYPRESS COVE OF WILMINGTON, LLC DESIGNED: CMC PO BOX 2400 BEAUFORT, NC 28516 DRAWN:

PHONE: 252-504-3996

STROUD ENGINEERING, P.A.


CMC DATE: 4/10/17


CMC CHECKED:


CMC


APPROVED: 5/ 151A HIGHWAY 24 MOREHEAD CITY, N.C. 28557 (252) 247-7479 LICENSE NO. C-0647 SCALE: CHARLES M. CULLIPHER P.E. 1 "=50 '

SHEET #C9.1 OF 10 PROJECT #:PM858-36'-001 DESIGN FILE #: Construction Drawings.dgn

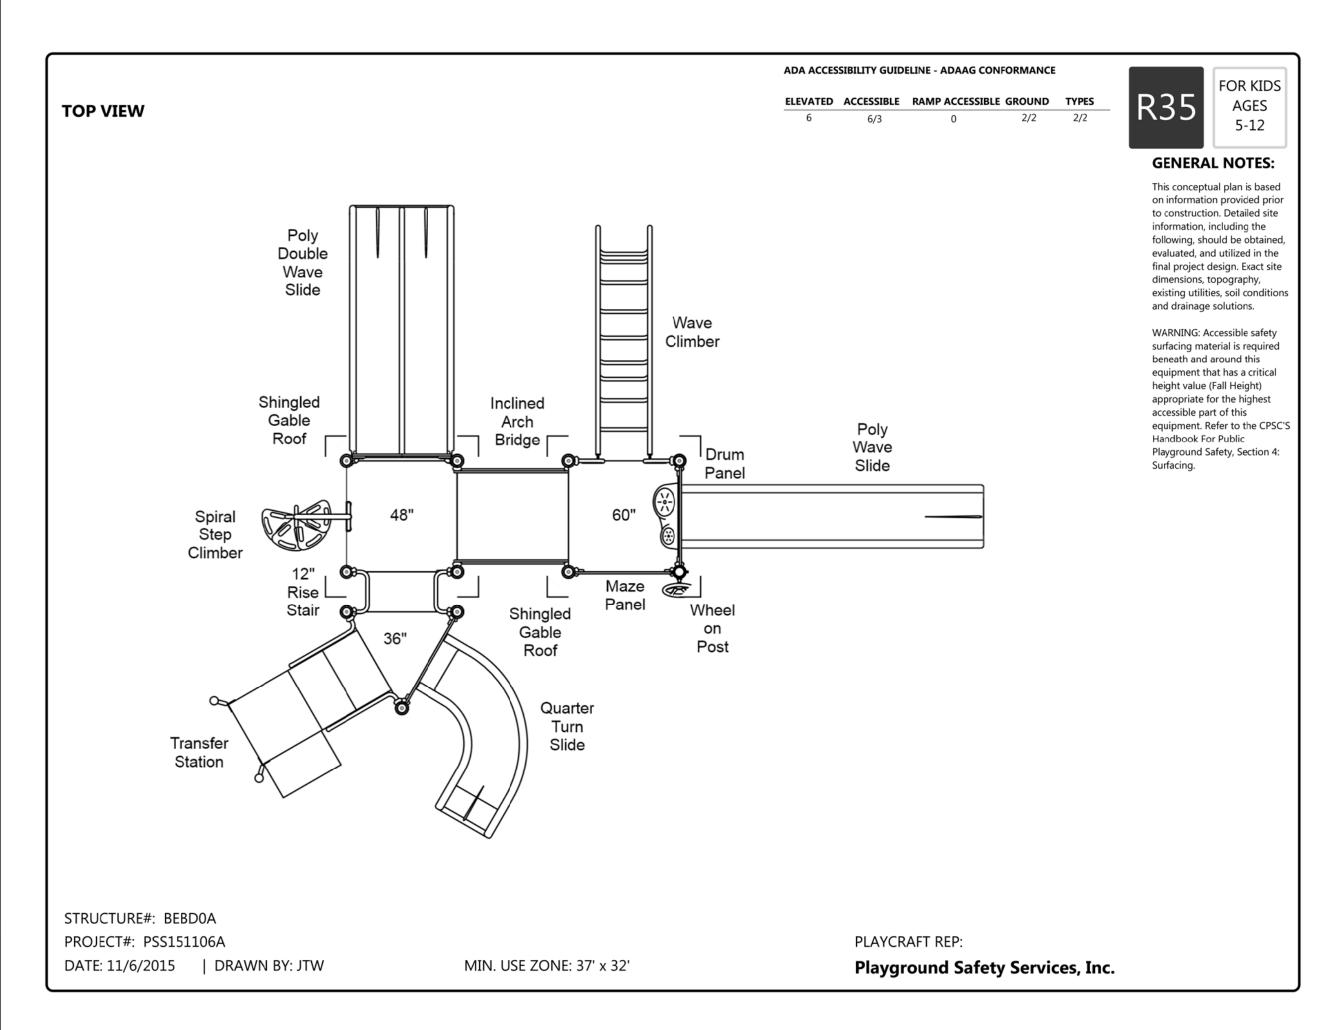

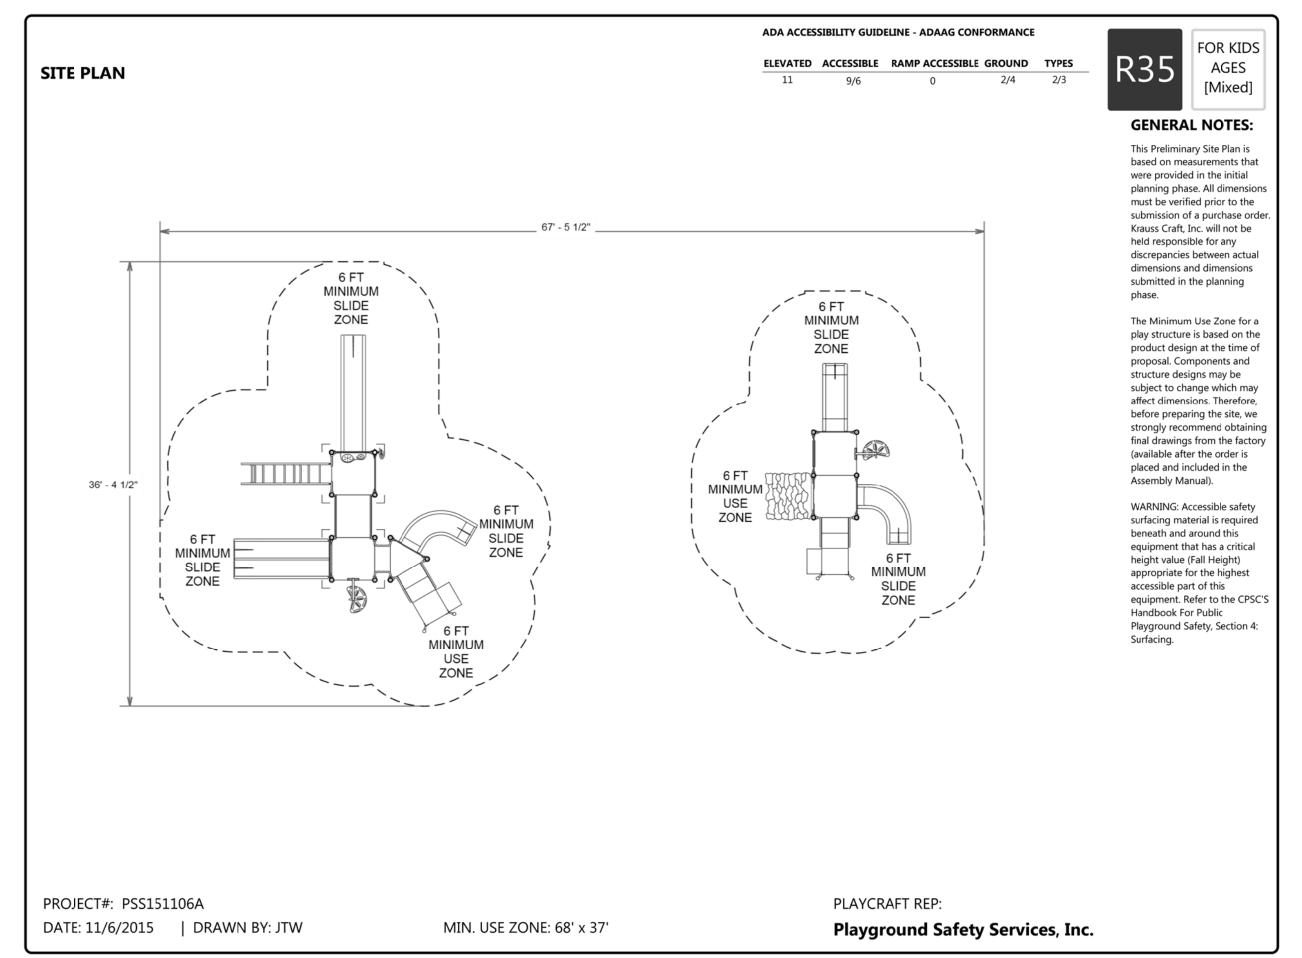

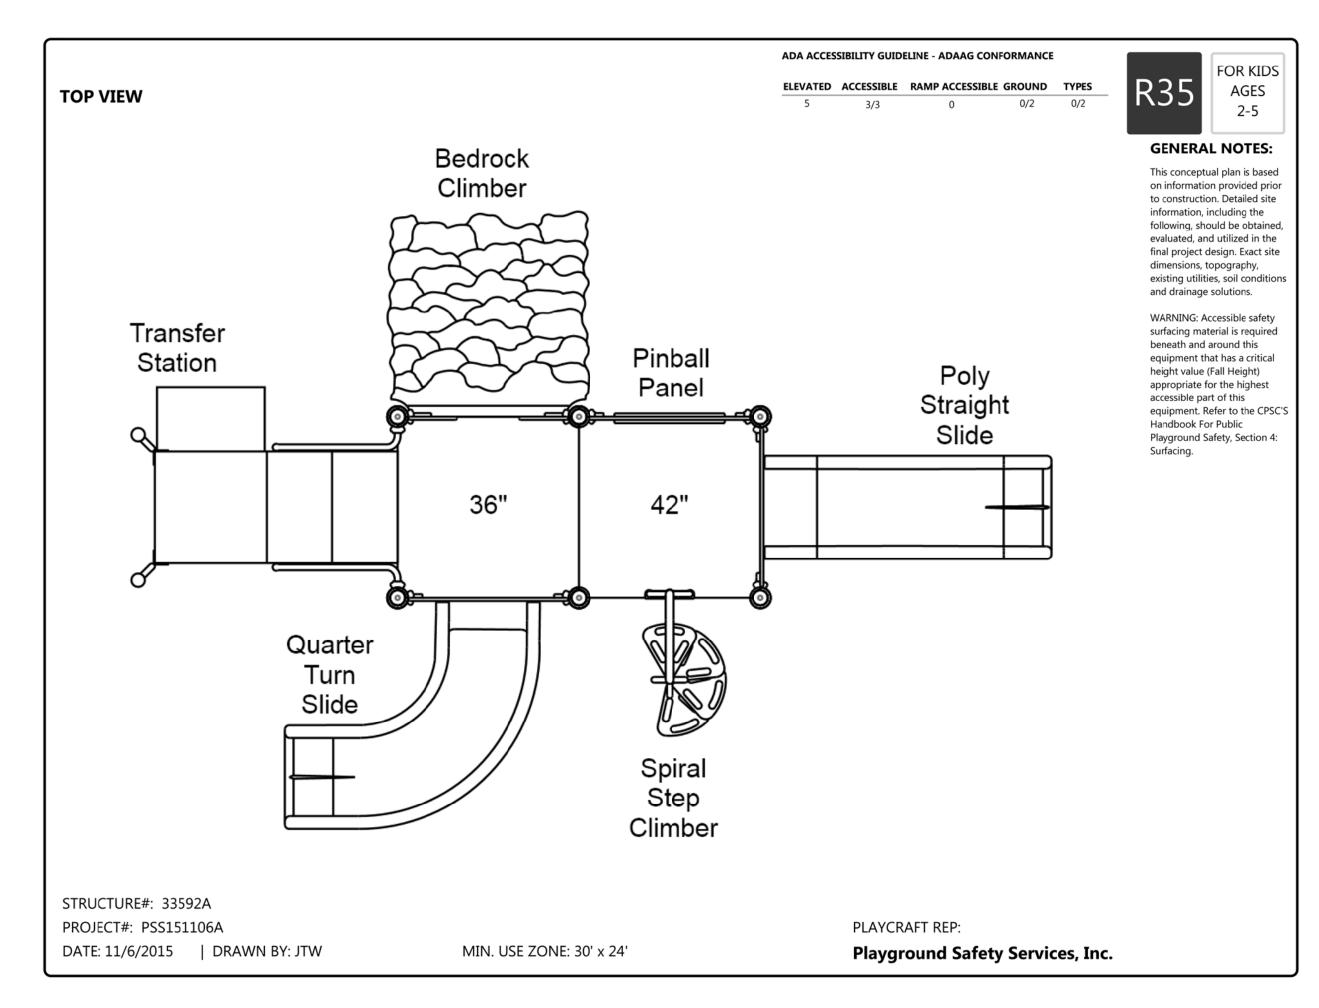

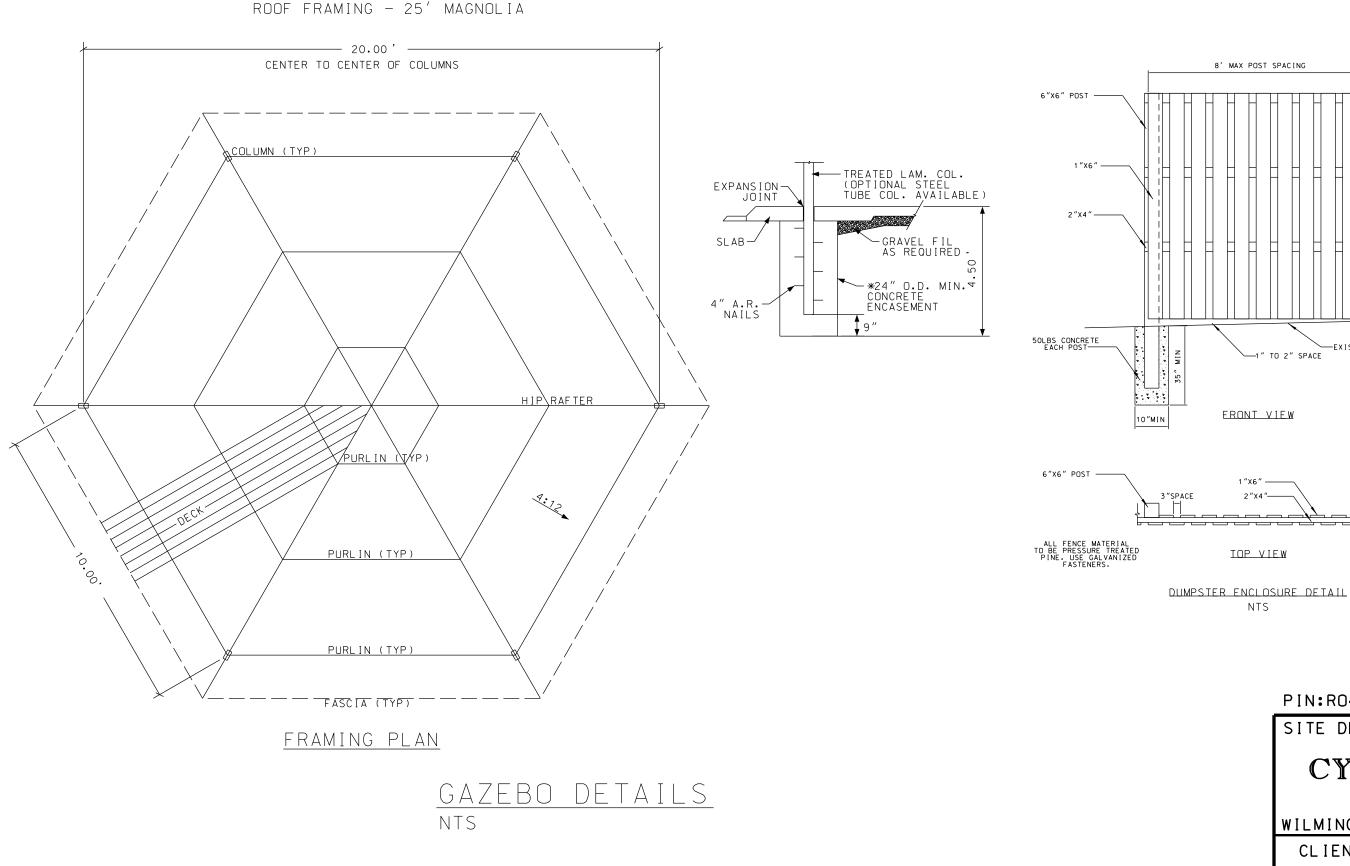

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Public Services • Engineering Division

APPROVED STORMWATER MANAGEMENT PLAN

Date: _____ Permit #____

Signed: ______

Approved Construction Plan
Name Date

Planning ____
Public Utilities _____
Traffic _____

Fire ______

REVISIONS:

REVINORITY PER WILL SAB.

3 CMC 4/6/17 PER WILL SAB.

3 CMC 4/10/17 PER WILL COMMENTS

SHEET #C OF 10 PROJECT #:PM858-36'-001

DESIGN FILE #: Construction Drawings.dgn

SITE DETAILS

CYPRESS COVE APART

CYPRESS COVE APARTMENTS
821 EMORY STREET

WILMINGTON TWSP., NEW HANOVER COUNTY, NORTH CAROLINA

CLIENT: CYPRESS COVE OF
WILMINGTON, LLC

CMC

CLIENT: CYPRESS COVE OF WILMINGTON, LLC PO BOX 2400 BEAUFORT, NC 28516

PHONE: 252-504-3996

SEAL 037378 PIN:R04812-001-004-000

STROUD ENGINEERING, P.A.

151A HIGHWAY 24

MOREHEAD CITY, N.C. 28557
(252) 247-7479

LICENSE NO. C-0647

4/

CHARLES M. CULLIPHER P.E.

DRAWN: CMC CHECKED:

CMC APPROVED:

CMC

